

AGENDA CITY OF HALF MOON BAY ARCHITECTURAL ADVISORY COMMITTEE (AAC) MEETING

THURSDAY NOVEMBER 21, 2019 8:30 A.M.

Ted Adcock Community Center (South Day Room) 535 KELLY Street Half Moon Bay, California 94019

Chad Hooker Steve Kikuchi Linda Poncini

This agenda contains a brief description of each item to be considered. Those wishing to address the AAC on any matter not listed on the Agenda, but within the jurisdiction of the Community Development to resolve, may come forward during the Public Comment portion of the Agenda and will have a maximum of three minutes to discuss their item. Those wishing to speak on a Public Hearing matter will be called forward at the appropriate time during the Public Hearing consideration.

Please Note: Please Provide a Copy of Prepared Presentations to the Planning Division.

Copies of written documentation relating to each item of business on the Agenda are on file in the Office of the City Clerk at City Hall where they are available for public inspection. If requested, the agenda shall be available in appropriate alternative formats to persons with a disability, as required by Section 202 of the Americans with Disabilities Act of 1990 (42 U.S.C. Sec. 12132.) Information may be obtained by calling 650-726-8271.

In compliance with the Americans with Disabilities Act, special assistance for participation in this meeting can be obtained by contacting the City Clerk's Office at 650-726-8271. A 48-hour notification will enable the City to make reasonable accommodations to ensure accessibility to this meeting (28 CFR 35.102-35.104 ADA Title II).

I. CALL TO ORDER

- II. REVIEW MEETING SUMMARY NOTES 10.17.19
- III. PUBLIC COMMENT

IV. COMMITTEE MEETING ITEMS

- a. INFORMATION ITEM: Pilot project for a temporary parklet within the publicright-of-way
 LOCATION: 522 Main Street
 OWNER/APPLICANT: City of Half Moon Bay / Café Society
- **PROJECT:** An application for a Coastal Development Permit, Use Permit, Architectural Review, and Parking Exception for the construction of a new two story mixed residential and commercial building.
 CITY FILE #: PDP-16-061
 LOCATION: 795 Main Street
 OWNER/APPLICANT: Moody Properties, LLC / RM Construction

V. DIRECTOR'S REPORT

VI. COMMITTEE MEMBER COMMUNICATIONS

VII. ADJOURNMENT

October 17, 2019 Architectural Advisory Committee (AAC) Page 1 of 2



MEETING SUMMARY NOTES CITY OF HALF MOON BAY ARCHITECTURAL ADVISORY COMMITTEE THURSDAY, OCTOBER 17, 2019 TED ADCOCK COMMUNITY CENTER, SOUTH DAYROOM / 535 KELLY AVENUE

First Meeting of the Architectural Advisory Committee (AAC) began at 8:30 am. The committee consists of: Chad Hooker, Steve Kikuchi, Linda Poncini.

PRESENT: Chad Hooker, Steve Kikuchi, Linda Poncini **STAFF PRESENT:** Jill Ekas, Scott Phillips and Bridget Jett

APPROVAL OF MEETING SUMMARY NOTES

None. First meeting.

PUBLIC COMMENT

None

SUMMARY

- No projects were presented.
- Swearing in of AAC members.
- Reviewed Bylaws
- Staff reviewed binder that was handed to each committee member.

ARCHITECTURAL ADVISORY DISCUSSION

- Overlap of planning and design: staff will provide guidance, and this will be better developed over time.
- Diverse input: staff explained that the Planning Commission is interested in the context of the design input and that staff and the Commission expect to be able to work with diverse input.
- Project interests: Design Guidelines
 - o Downtown priority
 - o Change/update existing for Single-family Residential
 - Highway 1 corridor

October 17, 2019 Architectural Advisory Committee (AAC) Page 2 of 2

MEETING FORMAT GOING FORWARD

- Applicant Presentation
- Public Comment
- AAC Discussion
- Staff Confirmation of Direction

ARCHITECTURAL ADVISORY COMMITTEE COMMUNICATIONS

ADJOURNMENT

Meeting adjourned: 10:30 am

Respectfully Submitted:

Bridget Jett, Planning Analyst



Architectural Advisory Committee: Request for Design Review and Recommendations

Date:	November 21, 2019
То:	Architectural Advisory Committee Members
From:	Scott Phillips
Subject:	522 Main Street, Parklet Pilot Project within Three Diagonal Parking Spaces Public Right-of-Way

PROJECT DESCRIPTION:

The project involves implementation of a temporary pilot project "parklet" consisting of tables, chairs, boardwalk, barricade, and landscaping of approximately 430 square feet within three vehicle parking spaces on Main Street. The improvements are designed to be removable when needed and have been evaluated by the City Engineer to ensure proper drainage and safety.

The primary purpose of the project is to establish high quality sidewalk café space in front of an existing Downtown café/restaurant business. Sidewalk dining space is a critical component to Downtown's vitality; however, sidewalks throughout the primary retail span of Main Street are narrow and limit options for outside seating areas. This pilot project will be evaluated to guide future approaches to expanding sidewalk space and outdoor use options. City staff also recently conducted a parking occupancy survey of Downtown and found that parking spaces are available on this block or within one-half block of the pilot location during all of the numerous peak periods evaluated. Staff will consider parking and other impacts of this pilot relative to the anticipated benefits to the Downtown pedestrian environment. This pilot may lead to future design standards, ordinances, or streetscape improvements.

REVIEW:


This project was developed prior to the appointment of the Architectural Advisory Committee. Staff is presenting the project to the Architectural Advisory Committee as an informational item.


NEXT STEPS:

The license agreement allowing for temporary improvements in the public right-of-way will be presented to the City Council, tentatively scheduled for one of its December sessions.


ATTACHMENTS:

1. Plan Set

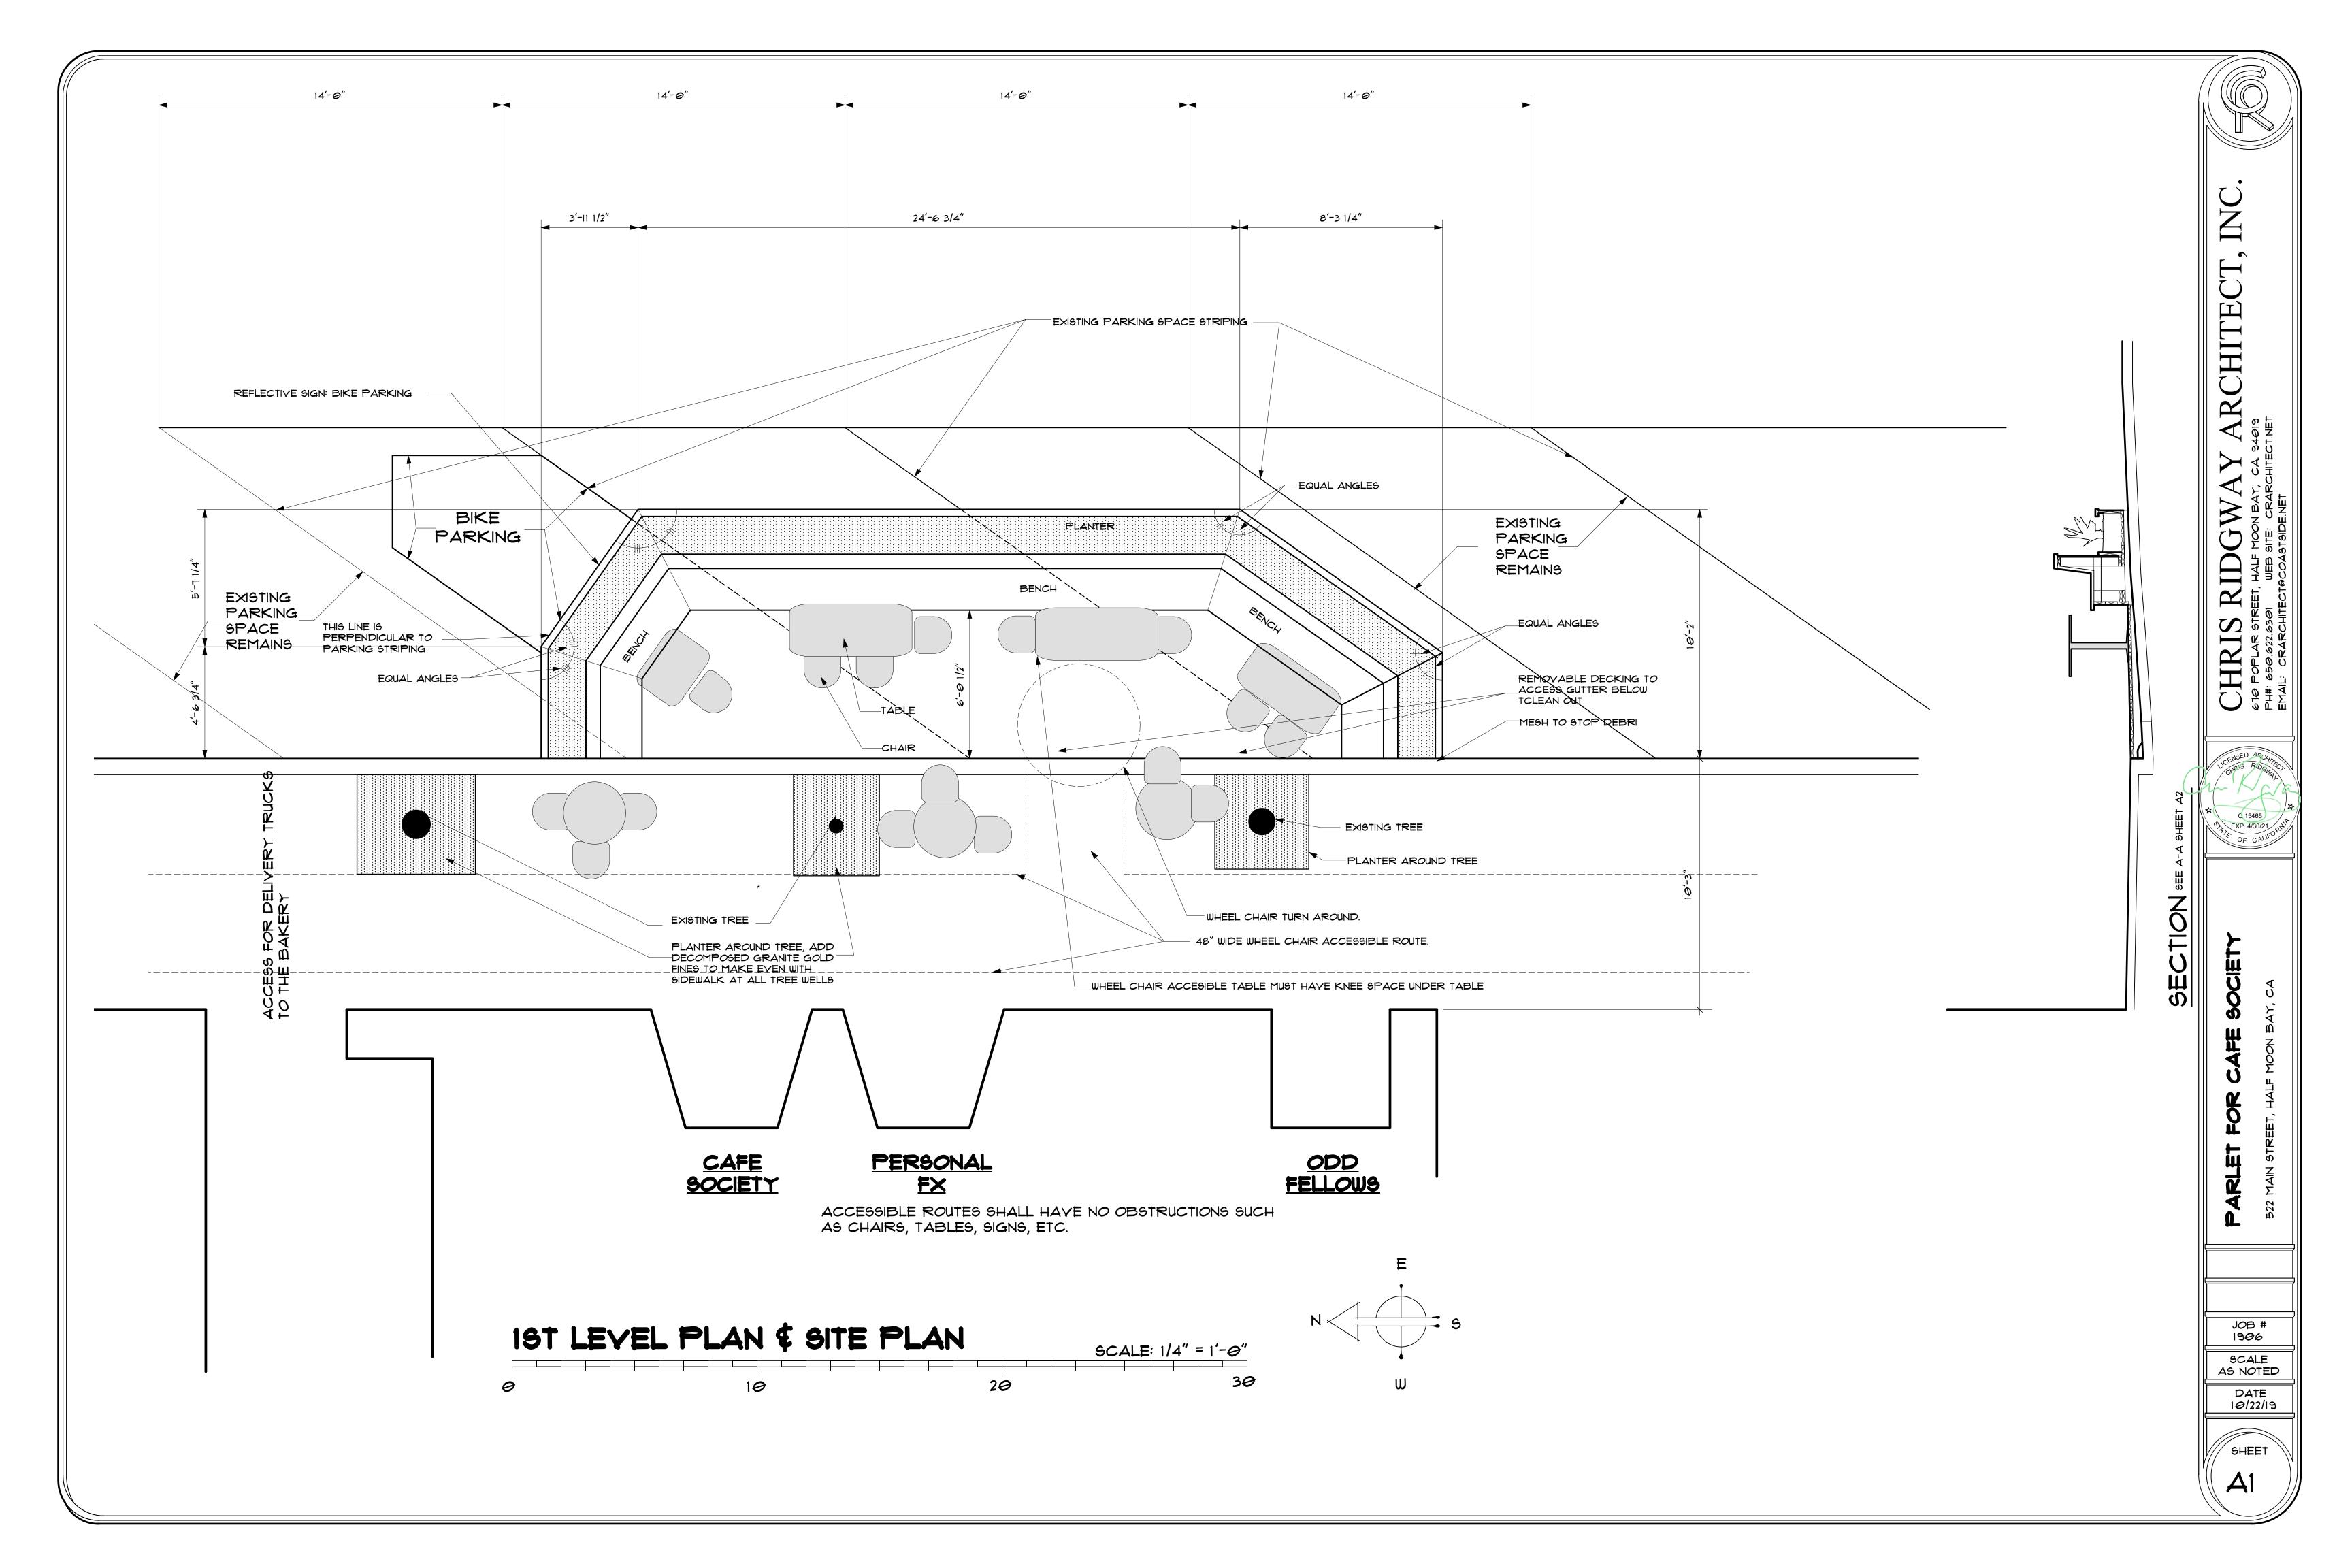

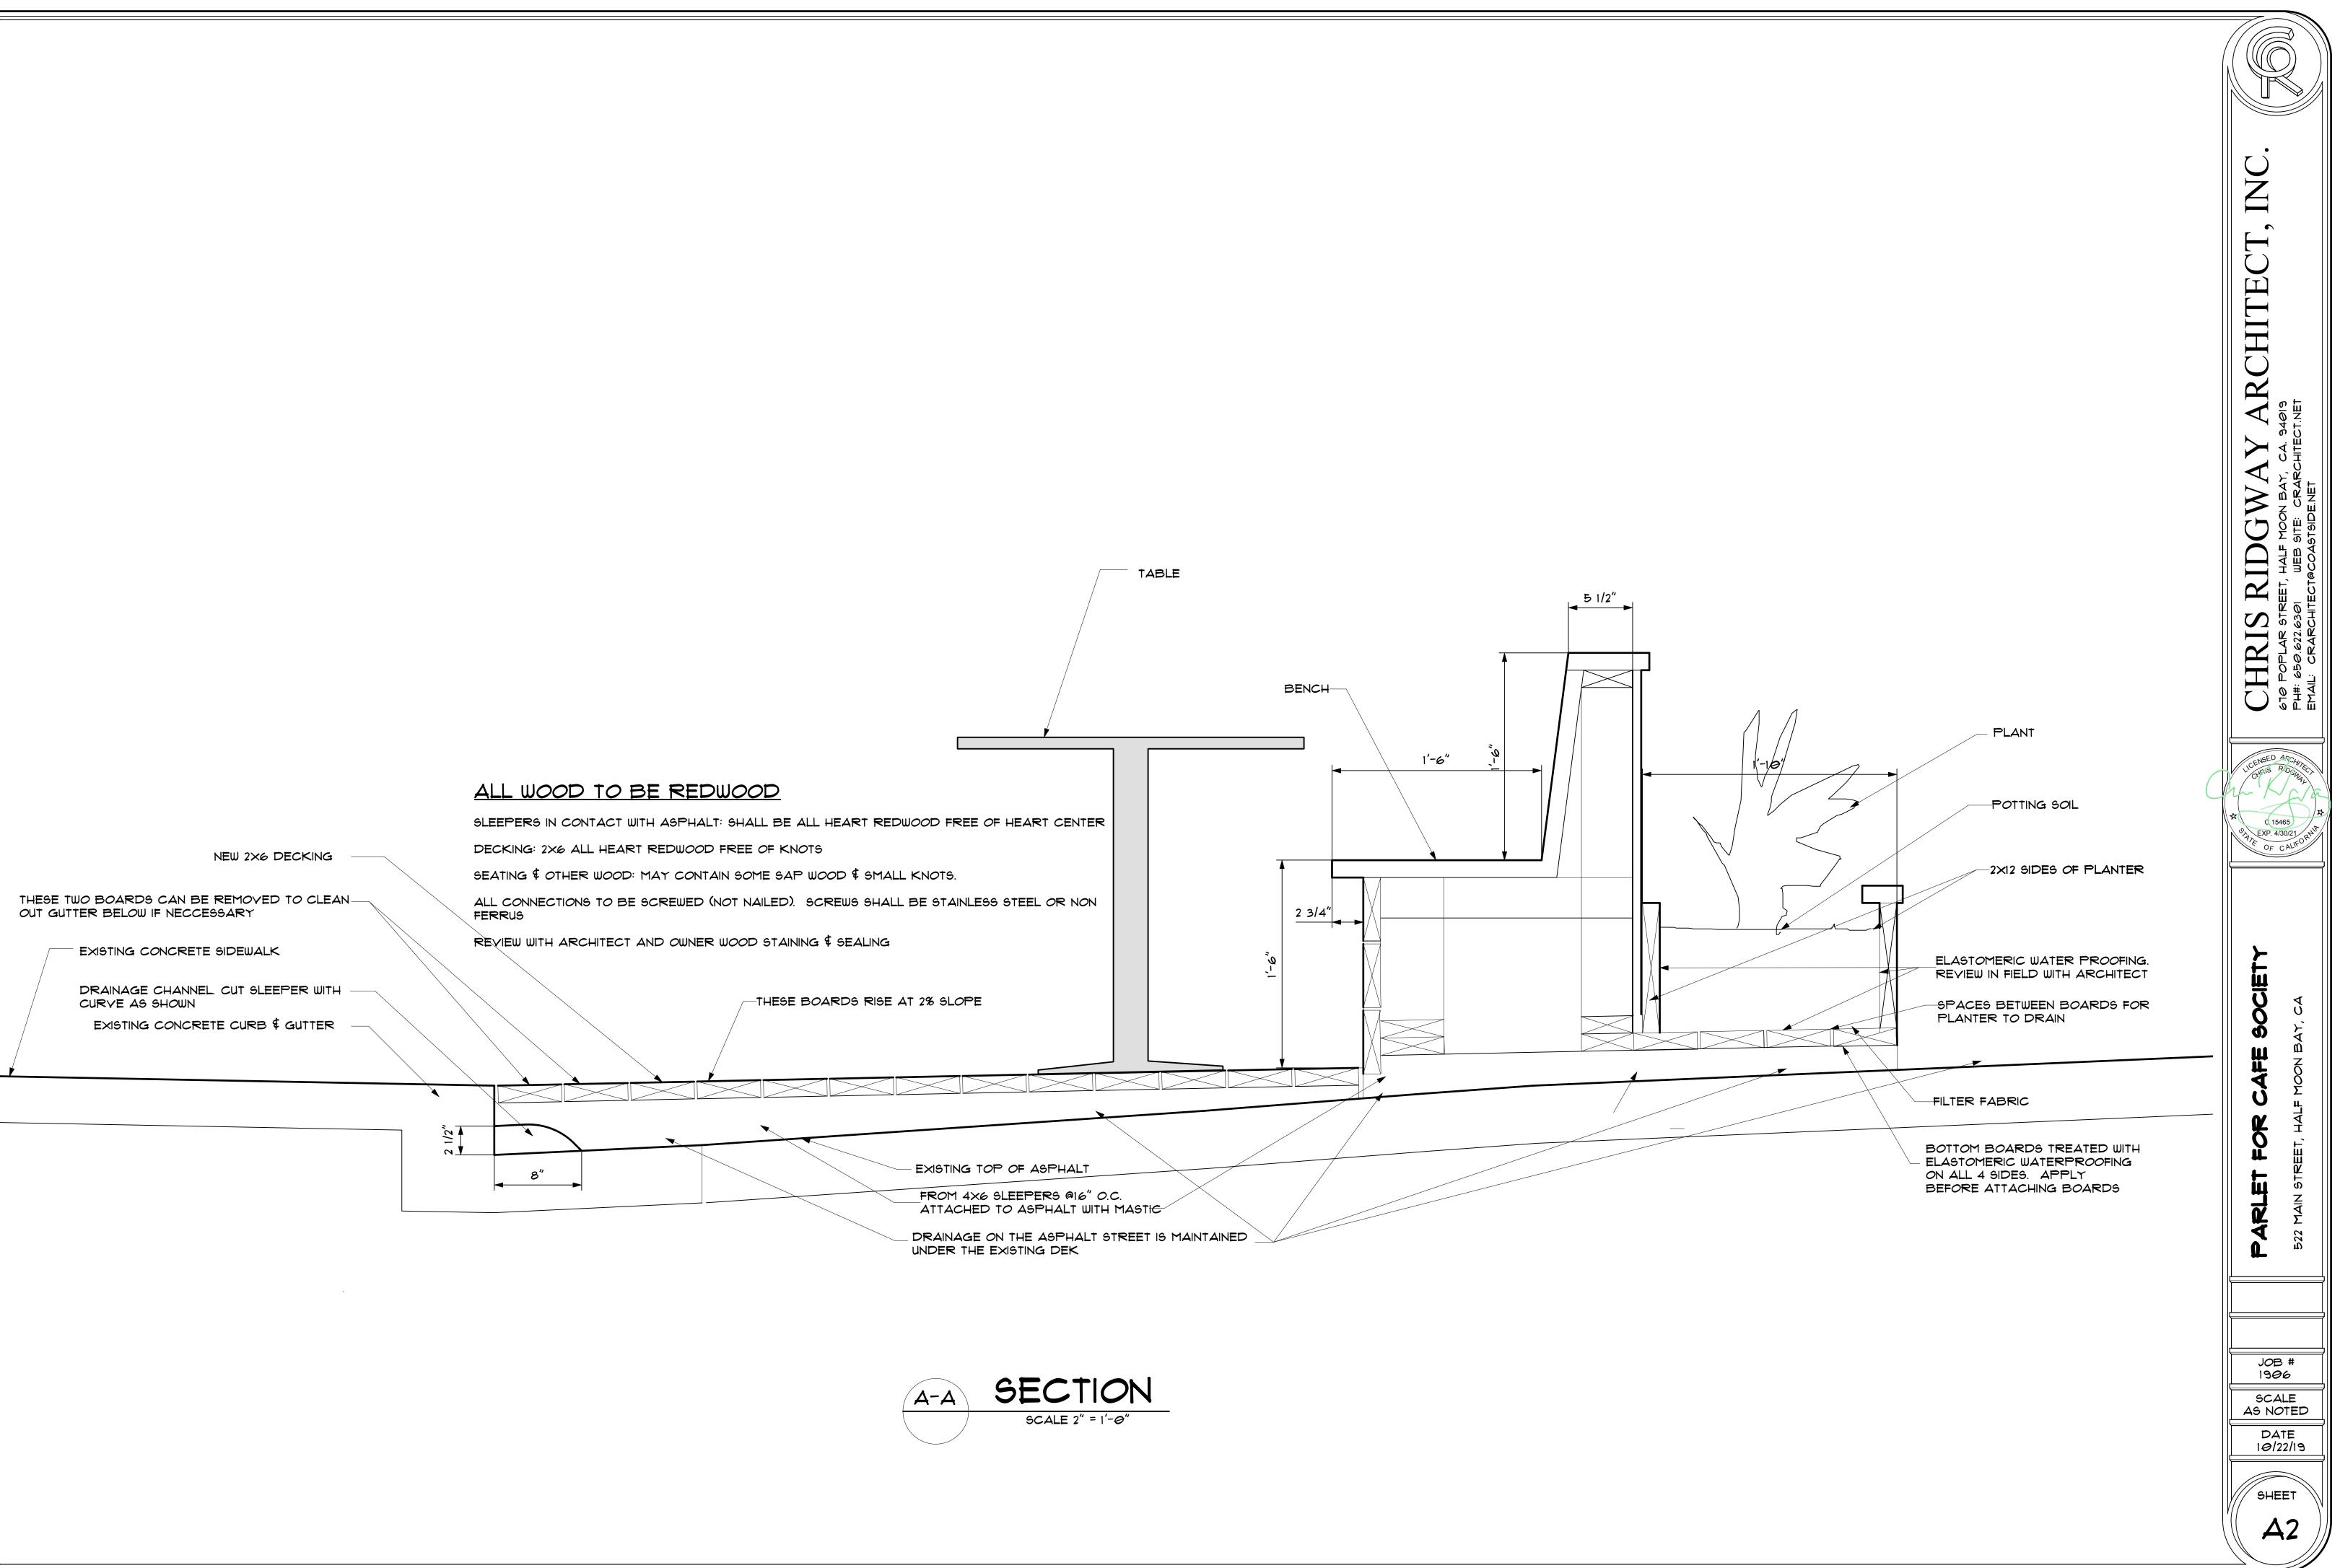



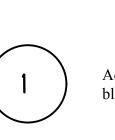

Aeonium Cyclopes, 2' wide 3' tall. Sun/shade. Moderate water. Yellow summer bloom. Available @ Highway 92 Succulents. 1 gallon.

Aeonium Mardi Gras, . 1' tall and 1' wide. Rosesettes of lemon yellow leaves emerald green mid-stripes that blush ruby rose. Moderate water. Full sun. Available @ Highway 92 Succulents. 1 gallon.




5


(2)

Aeonium Sunburst Flower is white, 3' tall and 2' wide. Moderate water. Full sun, partial shade. Available @ Highway 92 Succulents. 1 gallon.

Aeonium Canariense Fuzzy, 1' wide & 8" tall. Large rosette with fuzzy green leaves. Moderate water. Full sun. Available @ Highway 92 Succulents. 1 gallon.

Aeonium Fiesta, 1' wide & 8" tall. Four colored variegated leaves of forest green splashed with lime green, rose red, and burgundy on the outer leaves of rosette. Moderate water. Full sun. Available @ Highway 92 Succulents. 1 gallon.

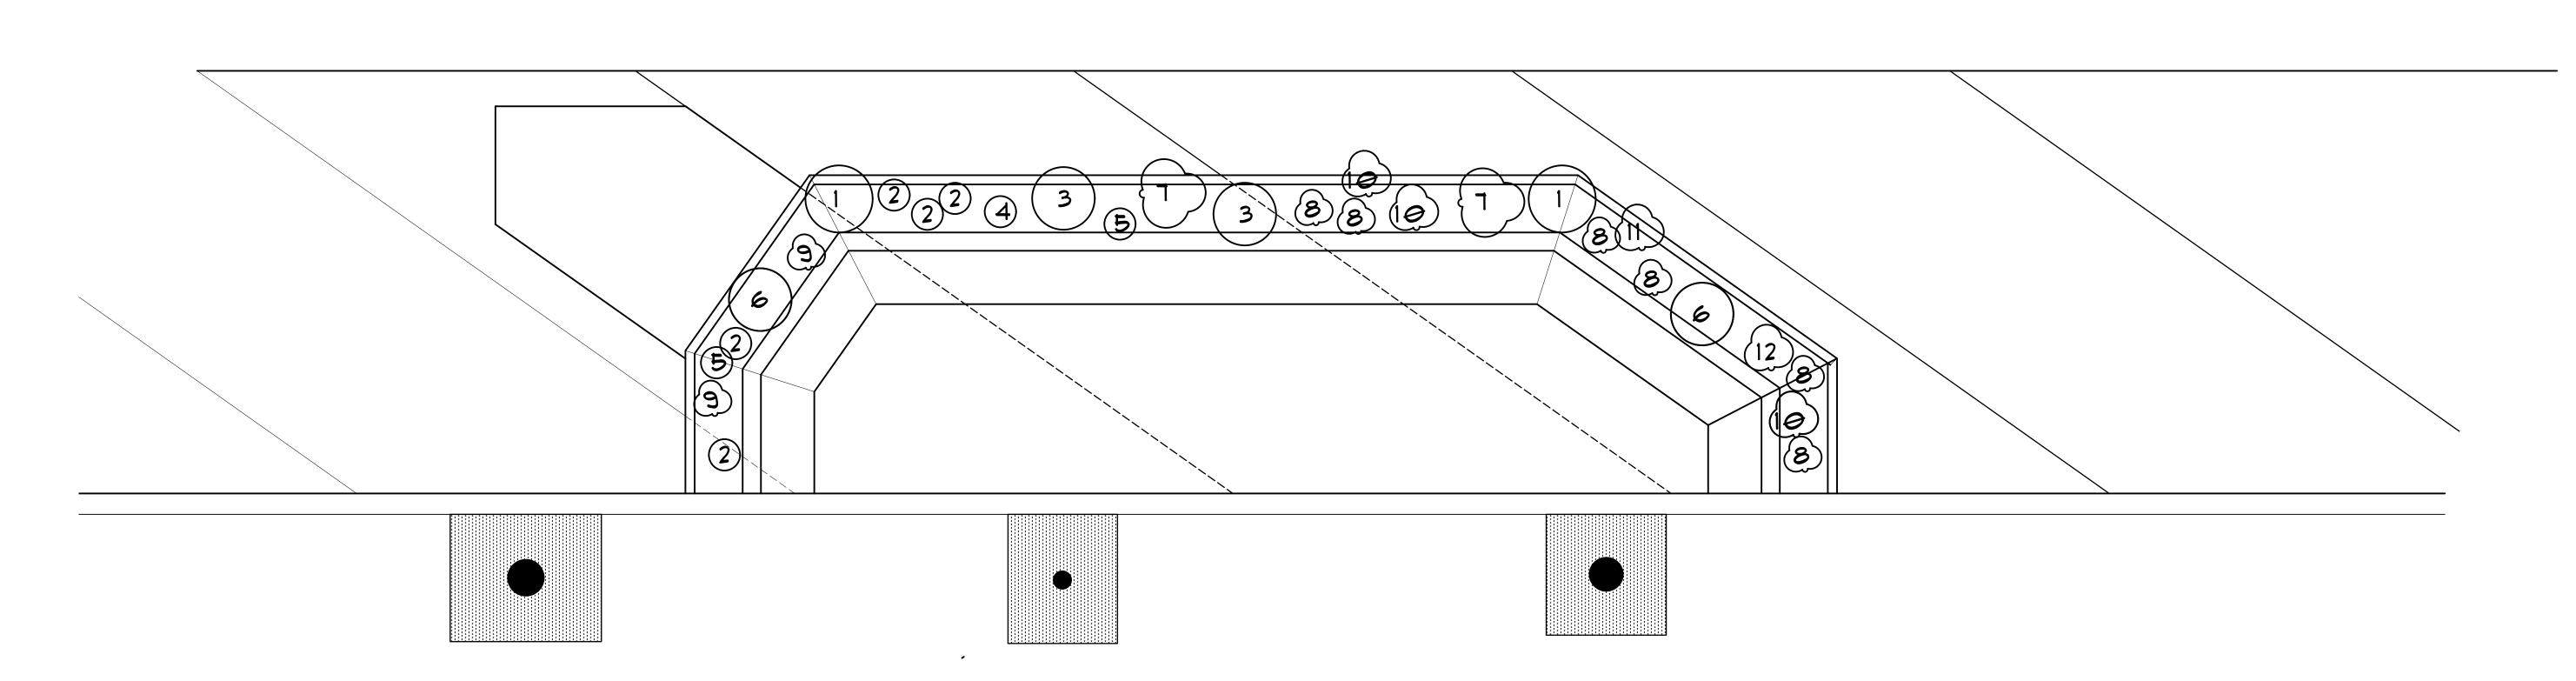

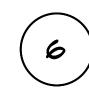

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Aeonium arboreum Atopurpureum, 3' tall. Yellow flowers in spring/summer. Moderate water. Full sun to part shade. Available @ Highway 92 Succulents. 1 gallon.



Sedum pachyphyllum Dedos, Low creeping stems with blue green leaves, reddish tips that are fleshy and cylindrical and bend upwards. Moderate water. Full sun on coast and pahrtial shade inland. Available @ Highway 92 Succulents. 1 gallon.



Aeonium Emerald Ice, 4' tall 2' wide. Rounded colony of bright green and creamy white flat rosettes. Grows to 4-5' tall and 3-4' wide. Moderate water. Full sun on coast and partial shade inland. Available @ Highway 92 Succulents.



(9)

Echevera Pui-oliver, Moderate water. 12" wide Nd 12" tallFull sun on coast and partial shade inland. Available @ Highway 92 Succulents. 1 gallon.

Sedum - Little Missy, Tiny green, cream and pink leaves with pink and white blooms. Grows to 6-8" tall. Full sun/partial shade. Moderate water. Available @ Highway 92 Succulents. 1 gallon.



gallon.



Sedum, repestre Angelina, 1' tall and 1-2' wide. Yellow flowers in summer. Sun or shade. Moderate water. Available @ Highway 92 Succulents. 1 gallon.

Soil in planters from Rice's Soil Farm. Use mix that is supplied to Highway 92 Succulents.

Sedum morganianaum Burrito, Hanging. the flowers are red in springtime. Moderate water. Partial shade. Available @ Highway 92 Succulents. 1



PARKLET FOR CAFE SOCIETY CHRIS RIDGWAY ARCHITECT





Architectural Advisory Committee: Request for Design Review and Recommendations

Subject:	795 Main Street, New Mixed-Use Development, PDP-16-061
From:	Scott Phillips, Associate Planner
То:	Architectural Advisory Committee Members
Date:	November 21, 2019

PROJECT DESCRIPTION:

The project includes a new mixed-use commercial/residential building on a site partially developed with a two-story commercial building.

Applicable Development Standards: The site is zoned Commercial Downtown (C-D).
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Development Standards	Zoning Requirements	Proposed	
Min. Site Area	5,000 sq. ft.	9,019 sq. ft. (After Merger)	
Min. Site Width	50 ft.	100 ft. (After Merger)	
Min. Front and Side Setbacks	Per 18.07.040 (B), not applicable	to mixed-use projects	
Min. Rear Setback	5 feet (adjacent to residential)	5 feet (proposed)	
Max. Site Coverage and Floor Area	Per 18.07.030 (C), not applicable	to mixed-use projects	
Max. Building Height	36 ft.	25 ft.	
Off-Street Parking Requirement: 2 Residential Units	4 garage spaces and 1 uncovered guest space	7 covered parking spaces, Parking	
Off-Street Parking Requirement: Commercial (existing & proposed)	1 space per 250 sq.ft. of commercial space= 15 spaces	Exception Required (-13)	
Bicycle Parking	3 short term spaces and 3 long term spaces	3 short term spaces and 4 long term spaces	

<u>Visual Resource Requirements, Design Guidelines, or Downtown Specific Plan:</u> The site is not within a visual resource area and/or within the Old Downtown as defined in the Visual Resource Protection Standards (Chapter 18.37). The proposed project is subject to architectural review per Chapter 14.37 and applicable design criteria. The site is also within the planning area boundaries for the Downtown Specific Plan.

<u>Required Permits</u>: Coastal Development Permit, Use Permit, Architectural Review and Parking Exception

REVIEW:

The Planning Commission held a study session on October 22, 2019 and provided initial input on this project. Staff brought this item forward to the Commission in advance of the Architectural Advisory Committee because the project is significantly under-parked with respect to the current zoning provisions. Because parking is a design driver for many components of this project, the Commission's input on parking was determined to be a prerequisite to design review. The Commission requested that the Architectural Advisory Committee review and provide recommendations. The Commission's input related to project design is summarized below:

Architecture

- Appreciates having an Architectural Advisory Committee; refer to Architectural Advisory Committee.
- Consider a taller building to reduce footprint, it does not block views from Highway 1
- North and south evaluations are flat; needs increased architectural/articulation interest
- Current design does not feel like a commercial building
- What can be done with the balconies?
- Solar important for this project

Parking

- On-street parking may be available currently, but with future development will be more heavily used and should not be relied upon; however, currently there are peak busy times in the area now,
- Kitty Fernandez Park should not be used as a parking area.
- Difference in this case between what is required and what is needed is too big; refer to the July Study Session discussion about parking; as proposed this project's parking would be sufficient. Not comfortable going well below those standards
- Open to creative solutions when it comes to parking; benefits should be brought forward, such as on-street public electric vehicle charging stations
- In the future there may be potential for use of the IDES lot for shard use
- Increase bike parking

BACKGROUND:

Site Plan

<u>Site Conditions</u>: The site contains a two-story commercial building with a building footprint of approximately 1,000 square feet. One driveway apron across the concrete sidewalk provides access to the site. The site is flat, does not include any environmental resources, and is part of an urbanized setting.

<u>Building Placement</u>: As identified in both the zoning ordinance and the Downtown Specific Plan, new buildings are to be placed close to the sidewalk to encourage walkability and continuity of the building setback.

<u>Parking</u>: The Planning Commission provided initial feedback regarding the requested parking exception and determined that parking provisions are inadequate. The applicant is researching options for reconfiguring the parking. That said, staff anticipates that the changes still won't meet future parking code requirements and some redesign will be necessary. For example, adding a new residential unit on the second floor of the existing building instead of the commercial space would eliminate the two required off-street parking spaces. In July 2019, the Planning Commission considered potential revisions to the City's parking requirements in a study session. The Commission advised this applicant to design the project to at least meet the draft parking standards evaluated during the July meeting.

Landscape

<u>Right-of-way</u>: The Downtown Specific Plan contains policies related to landscaping encouraging planting and maintaining street trees. Three Mayten street trees are proposed.

<u>Site</u>: Small pockets of landscaping are also included within the site layout. A variety of succulents, as well as two fruit trees would occupy the landscape pockets.

<u>Lighting</u>: The lighting plan needs to be evaluated. The Planning Commission requires dark sky approved fixtures.

Architecture

<u>Neighborhood Context</u>: The site is surrounded by a mixture of developed residential, commercial properties, and active recreation (City Park). The land use is fully consistent with the intended uses in Downtown and could support Downtown vitality in several positive ways along this span of Main Street.

<u>Building Envelope</u>: The new building as proposed is substantially lower than the maximum allowed height. As noted by the Planning Commission, it may be possible for the building to be increased in height in order to free up site area for open space or parking.

<u>Architectural Elements</u>: The building is L-shaped with a simple gable roof form. Three balconies provide open space for second-story uses. Staff is seeking the Architectural Advisory Committee's input with respect to building articulation, fenestration, and street presence in particular.

<u>Use Considerations</u>: Similar mixed-use buildings are located to the north and south. The site is across the street from Kitty Fernandez Park. Developed residential lots abut the site to the east. The proposed mixed-use building would be compatible with the existing development to the north and south along Main Street.

<u>Sustainability Features</u>: The Planning Commission has requested incorporation of sustainability features in all recently approved mixed-use projects. The Architectural Advisory Committee is encouraged to provide guidance for incorporating such measures.

<u>Signage</u>: Within the new building, a designated area for business signage will need to be designed into the project. In general, free-standing signs, which tend to be suburban in nature, are discouraged in Downtown. Storefront signage, including building façade signs, blade signs, and other pedestrian oriented approaches are encouraged.

NEXT STEPS

Staff recommends that the Architectural Advisory Committee provide design recommendations. Staff will work with the applicant to address recommended revisions. If needed, the revised project design will be presented to the Architectural Advisory Committee for further design review. Once project design can meet the required design criteria and findings, the project will be presented to the Planning Commission for a decision on the requested permits.


ATTACHMENTS:

1. Plan Set



795 MAIN STREET HALF MOON BAY, CA

RM CONSTRUCTION PLANNING SET RESUBMITTAL 2019.0830

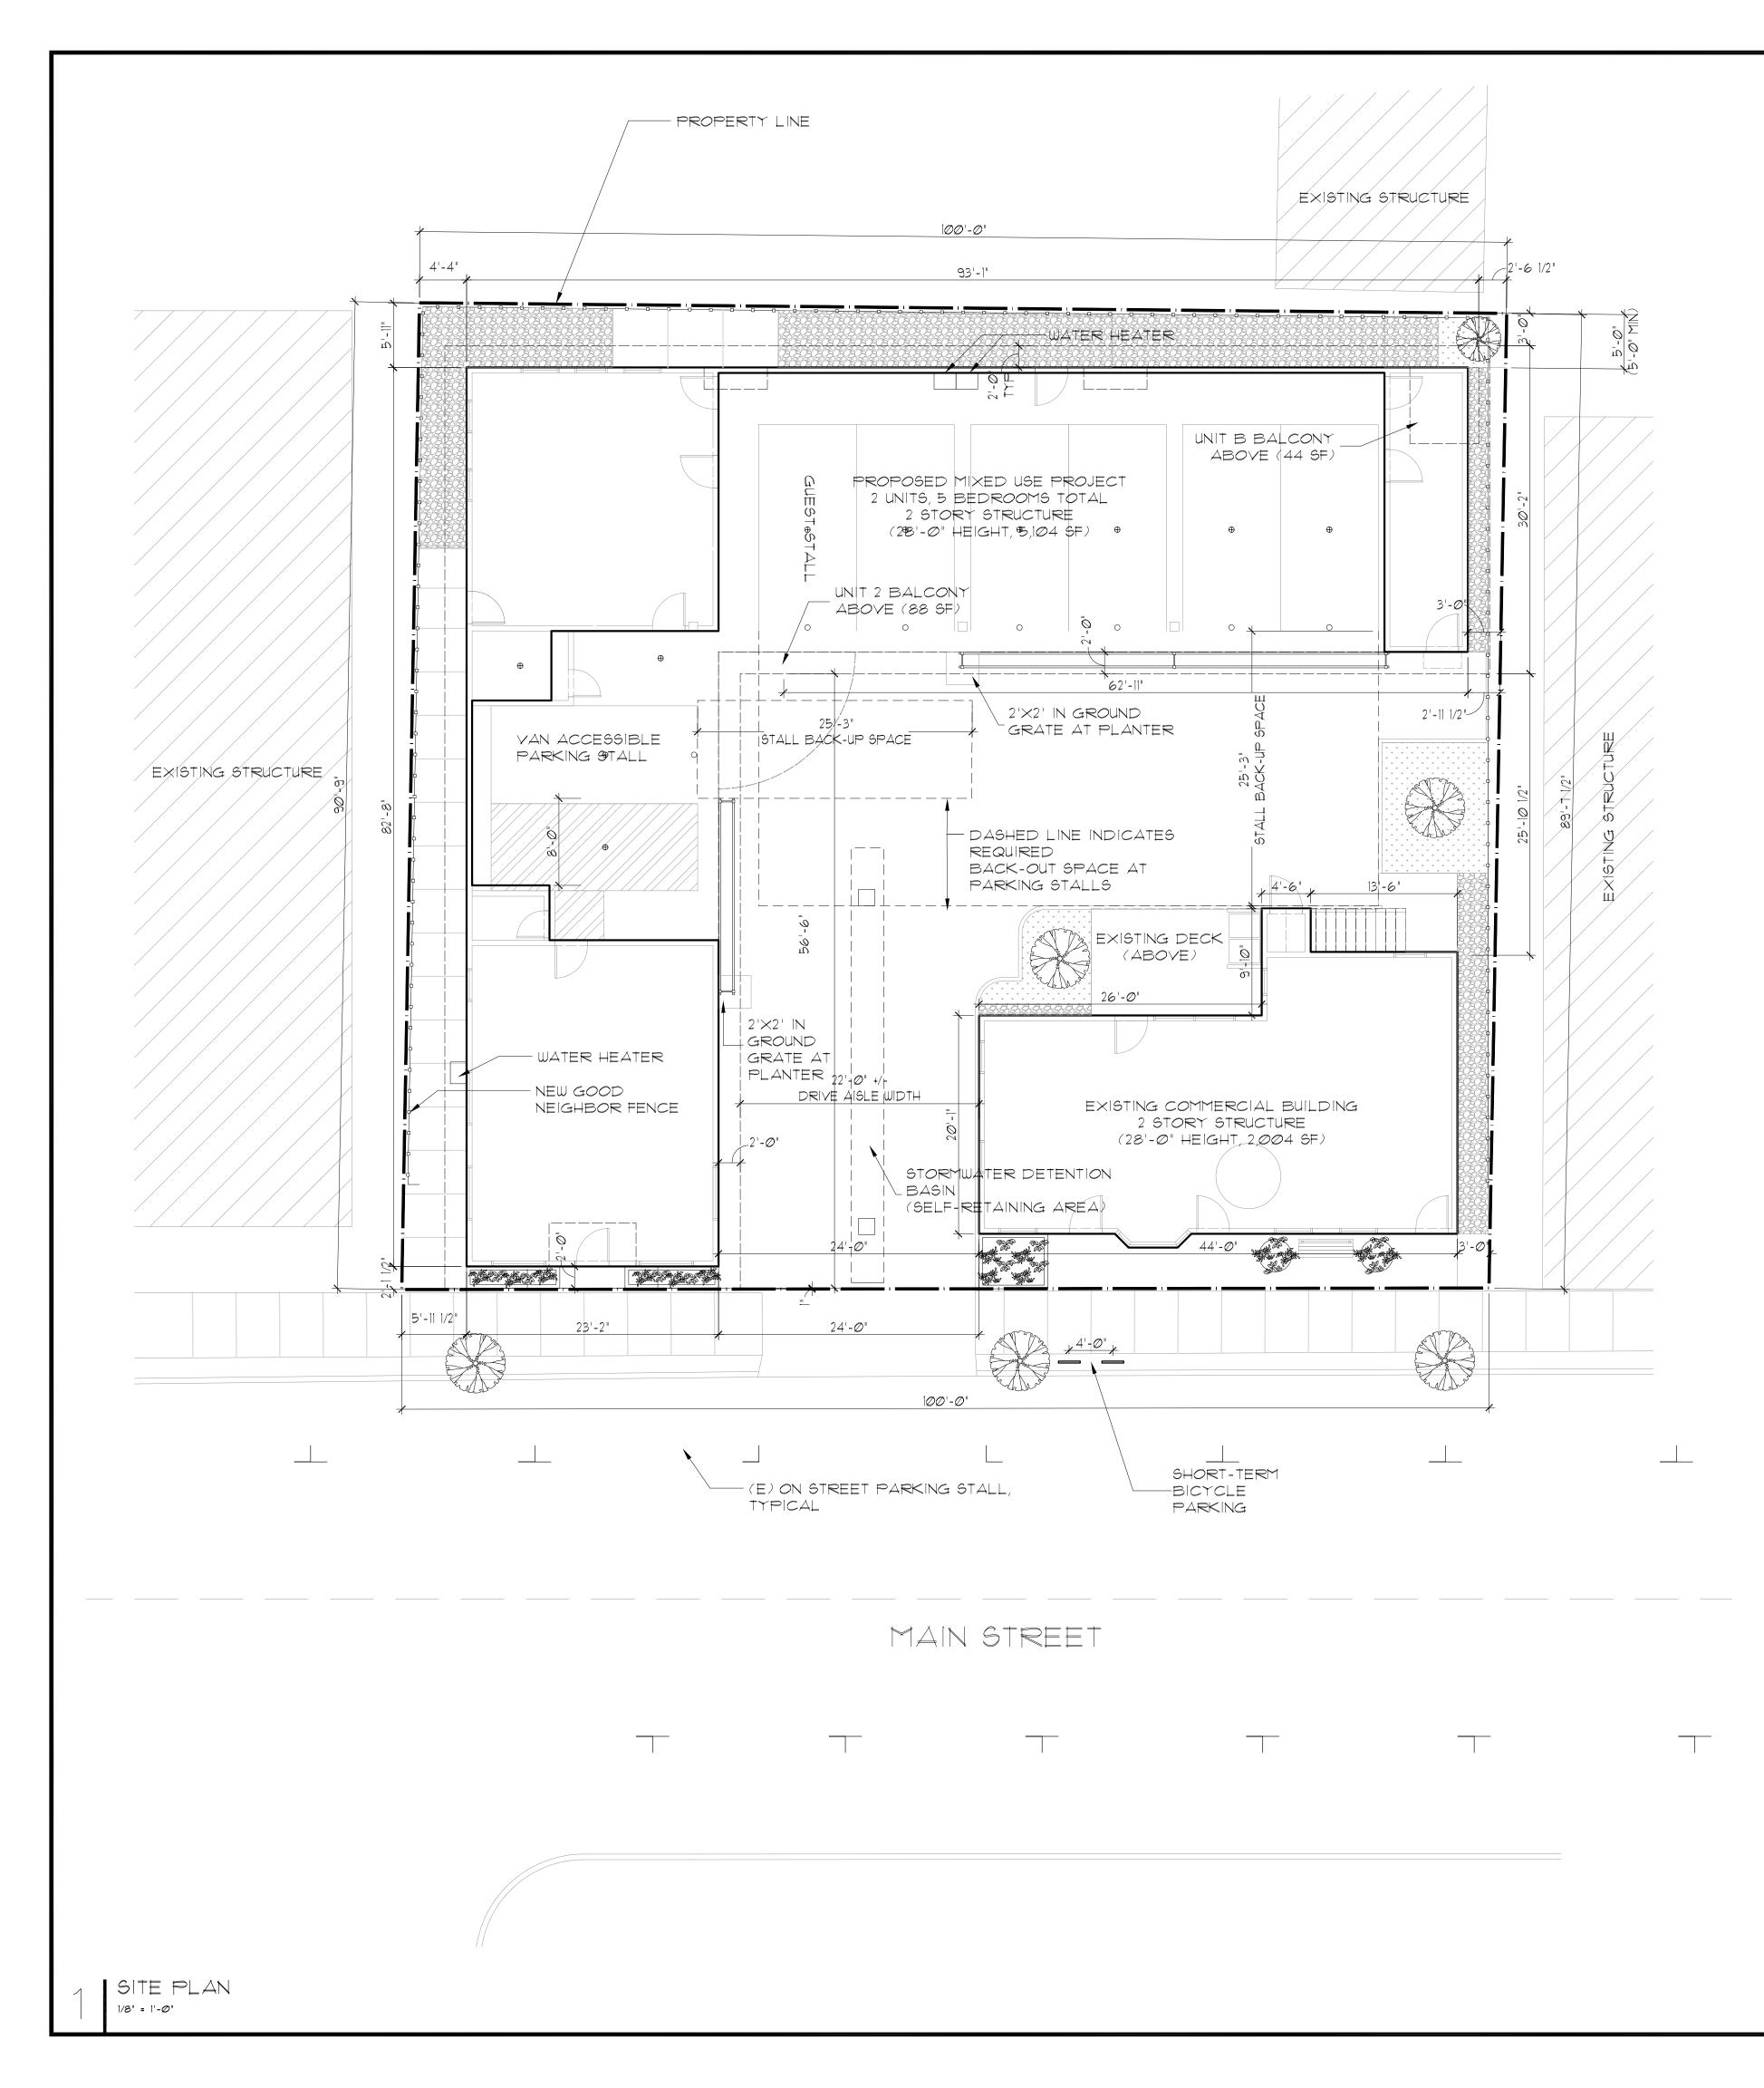

PROJECT INFORMATION

ZONING: COMMERCIAL DOWNTOWN (C-D) DOWNTOWN SPECIFIC PLAN

<u>LOT AREA:</u> 9,019 SF

<u>F.A.R. CALCULATION:</u> PROPOSED BUILDING ARE EXISTING BUILDING AREA: SITE AREA: PROJECT F.A.R.:	,
<u>LOT COVERAGE:</u> EXISTING STRUCTURE: PROPOSED STRUCTURE: SITE AREA: TOTAL LOT COVERAGE:	1,014 SF 3,718 SF <u>9,019 SF</u> 52.50%
PARKING CALCULATIONS:	(SEE A2.Ø1
EXISTING STRUCTURE: TOTAL PARKING REQ TOTAL PARKING PRO	
PROPOSED STRUCTURE: RESIDENTIAL: 2 STALLS PER UNIT: GUEST STALL: 1 TOTAL TOTAL PARKING REQ TOTAL PARKING PRO	L WIRED: <u>5 8</u>
COMMERCIAL: TOTAL PARKING REQ TOTAL PARKING PRC	
TOTAL: TOTAL PARKING REQ TOTAL PARKING PRO (SEE INCLUDED PARK	VIDED (E>
<u>BICYCLE PARKING:</u> SHORT TERM BICYCLE PA LONG TERM BICYCLE PAR	

SHEET INDEX

A1.Ø1 A1.Ø2	SITE PLAN AND PROJECT INFORMATION TOPOGRAPHIC AND BOUN SURVEY
A2.01	FIRST FLOOR PLAN
A2.02	SECOND FLOOR PLAN
A2.03	ROOF PLAN
A3.01	PROPOSED ELEVATIONS
A3.02	PROPOSED ELEVATIONS
A3.03	INCL (E) BUILDING
A4.01	EXISTING AND PROPOSED
A5.01	DETAILS
C1	GRADING AND DRAINAGE
C2	EROSION CONTROL PLAN
C3	ADA PLAN
C4	UTILITY PLAN

CONCEPTUAL LANDSCAPE PLAN L1.Ø1



6F (3,480 SF RESIDENTIAL, 1,655 SF COMMERCIAL) ,004 SF (COMMERCIAL)

DI FOR LOCATIONS)

PER 250 SF = 8 STALLS (2,004 / 250)<u>STALLS</u> (SEE INCLUDED PARKING EXCEPTION)

< 2 = 4 STALLS

<u>STALLS (1 ACCESSIBLE)</u>

PER 250 SF = 7<u>STALLS</u> <u>STALLS</u>(SEE INCLUDED PARKING EXCEPTION)

XISTING AND PROPOSED BUILDINGS): 20 STALLS EXISTING AND PROPOSED BUILDINGS): 1 STALLS CEPTION REQUEST FOR PARKING STALLS NOT PROVIDED)

REQUIRED, 4 PROVIDED (SEE A2.01) REQUIRED, 2 PROVIDED (SEE A2.01)

PROJECT TEAM

<u>ouner</u> ROBERT A AND JANICE MOODY NDARI RM CONSTRUCTION 532 PURISSIMA STREET HALF MOON BAY, CA 94019 650-867-3971 <u>ARCHITECT</u> JOHN P WALTER

547 GATES ST SAN FRANCISCO CA 94110 ED VIEWS <u>CIVIL ENGINEER</u> CHARLES KISSICK SIGMA PRIME GEOSCIENCES, INC PLAN 332 PRINCETON AVE

HALF MOON BAY, CA 94019 650-728-3590

795 MAIN STREET

RM CONSTRUCTION HALF MOON BAY, CA





NO. DATE 08.26.16 PLANNING SET

ISSUES AND REVISIONS DESCRIPTION

05.10.17 PLANNING RESUBMITTAL 04.11.18 PLANNING RESUBMITTAL 07.01.19 PLANNING RESUBMITTAL 08.30.19 PLANNING RESUBMITTAL

PROJECT NUMBER 160401


SHEET TITLE SITE PLAN AND PROJECT INFORMATION

> SCALE 1/8" = 1'-0"

N 🗲 8'

SHEET NUMBER

A1.0

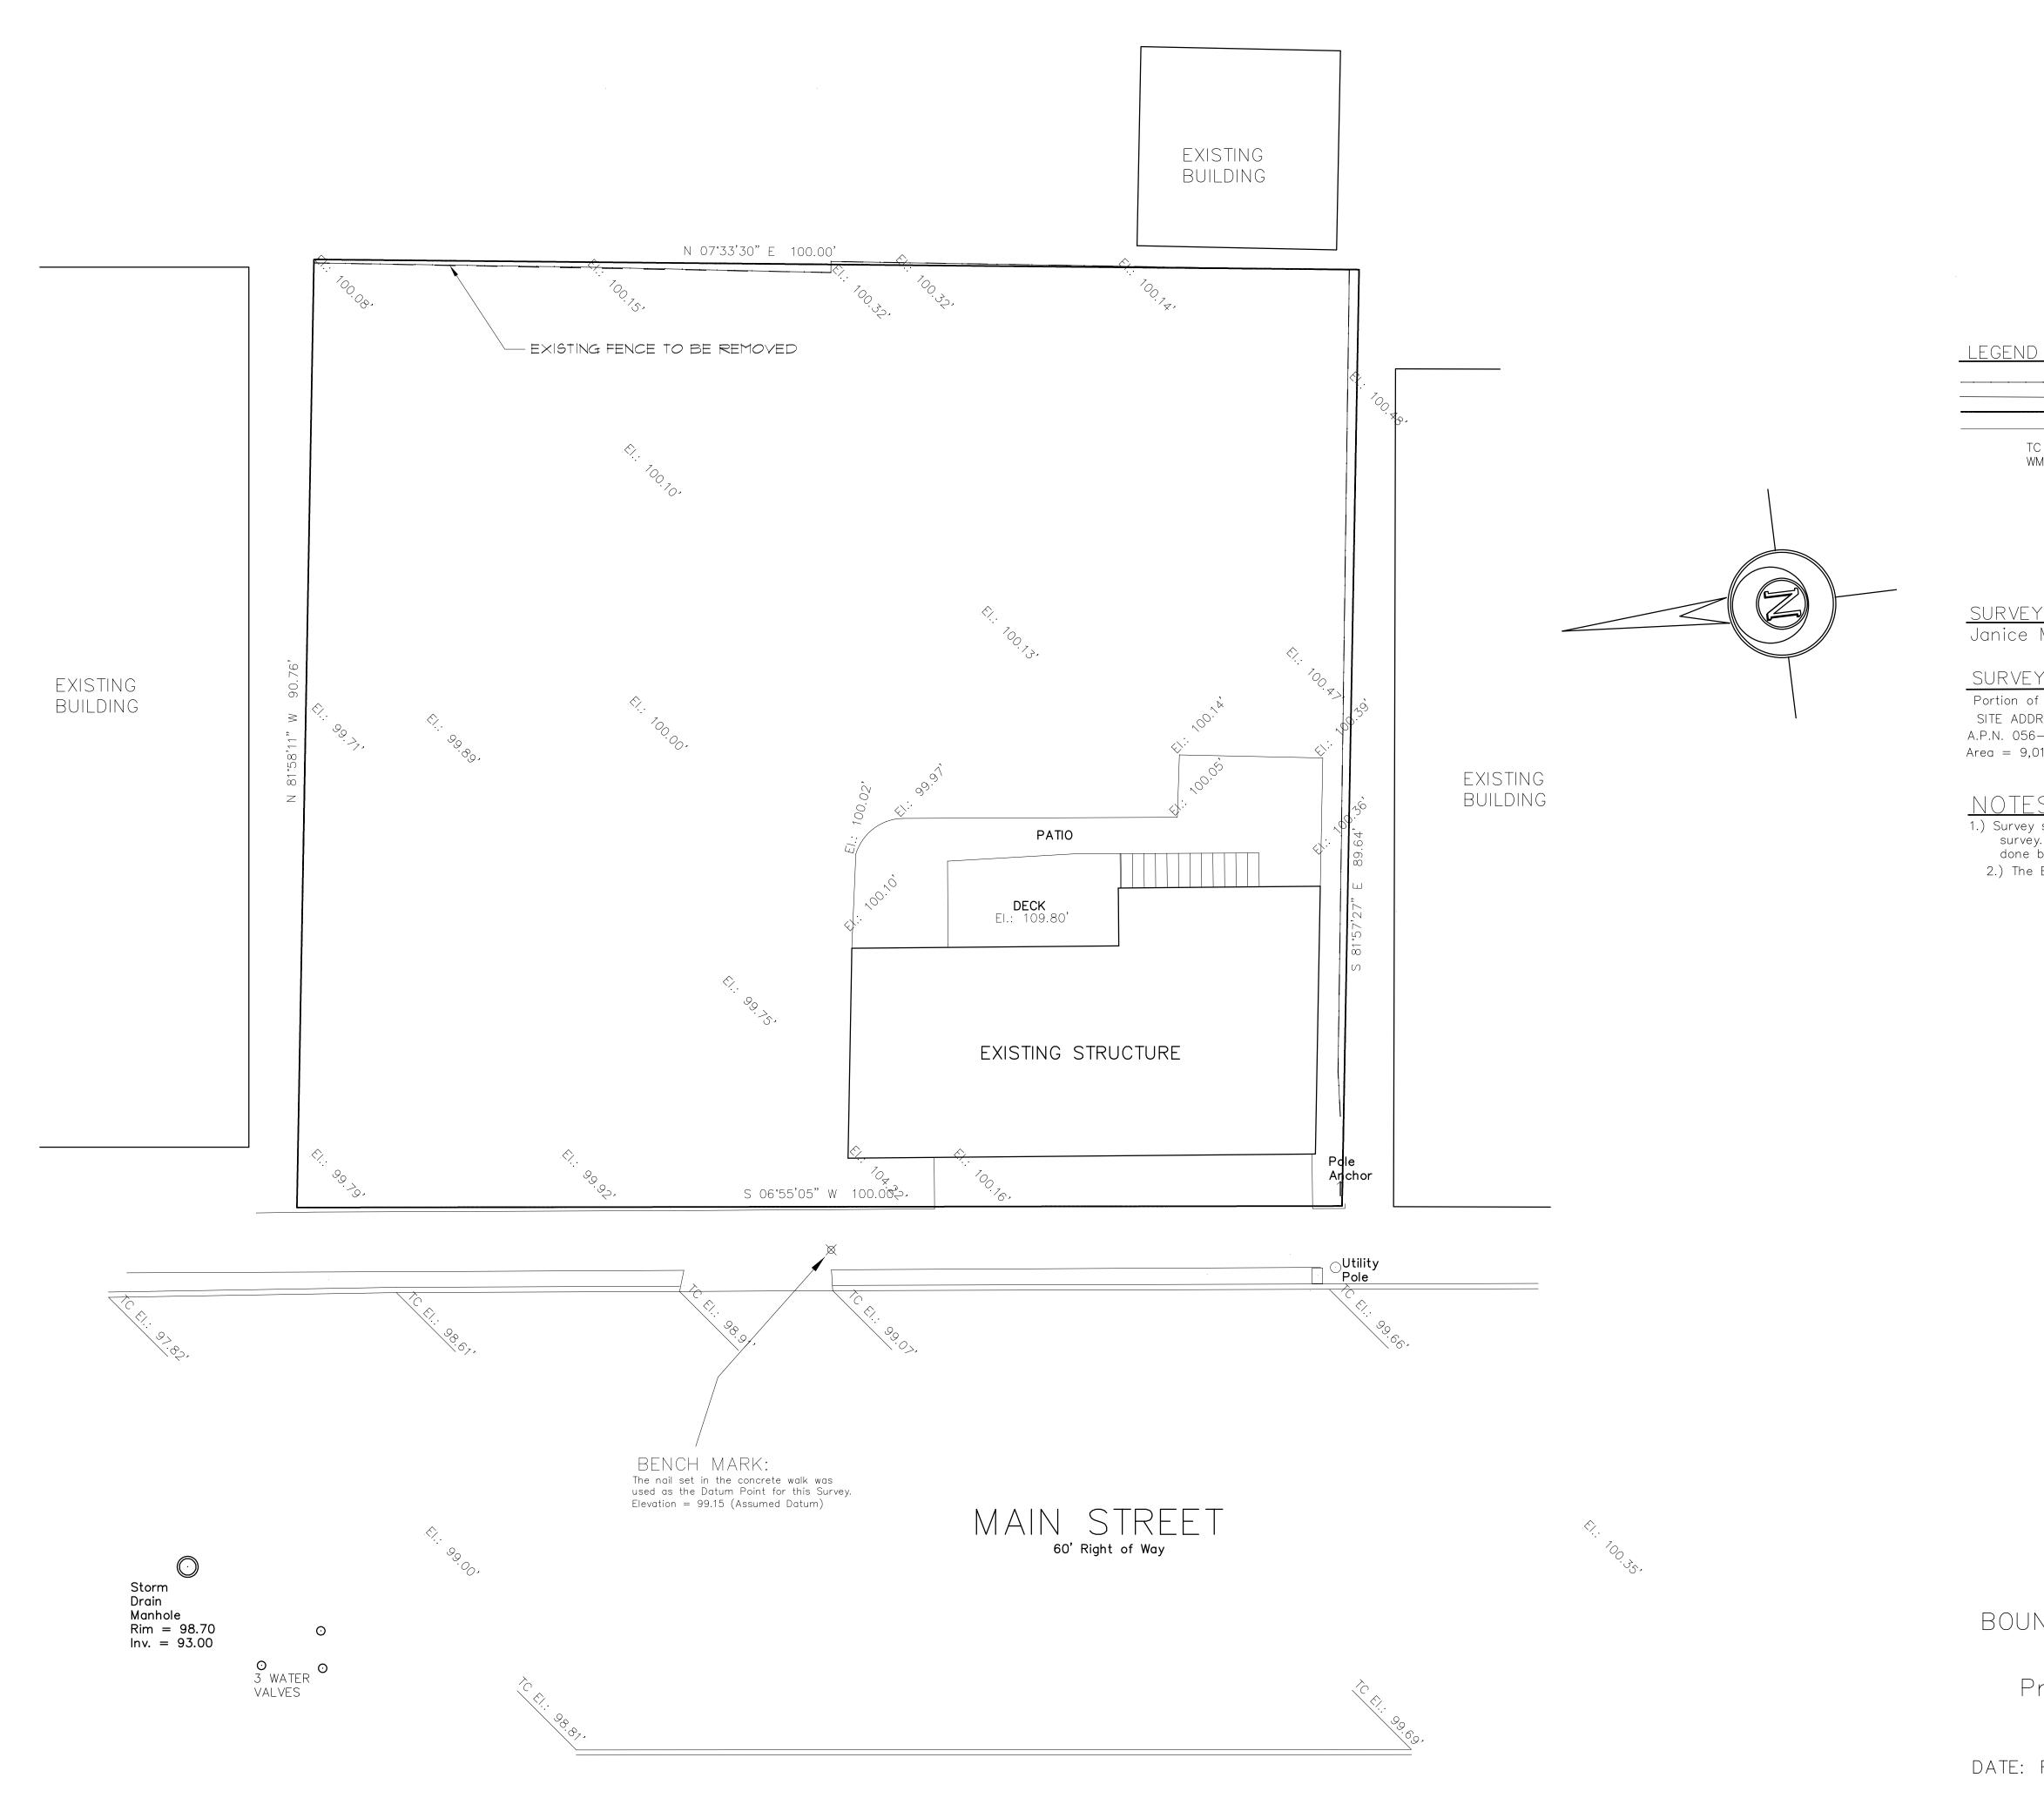

Fence Edge of Pavement - Property Line Easement Line TC WM Top of Curb Water Meter Portion of Sub #4 of R.S.M. Book 1 of Maps pg. 61 5-3652 10 - 31 - 2019 RENEWAL DATE 2.) The Elevations shown are based upon an Assumed Datum. NO. DATE DESCRIPTION 08.26.16 PLANNING SET 05.10.17 PLANNING RESUBMITTAL 04.11.18 PLANNING RESUBMITTAL 07.01.19 PLANNING RESUBMITTAL 08.30.19 PLANNING RESUBMITTAL TOPOGRAPHIC AND BOUNDARY SURVEY

BOUNDARY & TOPOGRAPHY MAP Prepared By: Pat McNulty Professional Land Surveyor 1604 Francis Avenue Belmont, California 94002 650-654-6460 DATE: FEBRUARY 2016 JOB NO.: 2-16 JOB NO.: 2-16

A1.02

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795 MAIN STREET

RM CONSTRUCTION HALF MOON BAY, CA

ISSUES AND REVISIONS

PROJECT NUMBER 160401

SHEET TITLE

SCALE

1/8" = 1'-0"

SHEET NUMBER


SURVEY FOR: Janice Moody

SURVEY OF: SITE ADDRESS: 795 Main Street, Half Moon Bay A.P.N. 056-192-160

Area = 9,019.08 sq. ft.+/-

NOTES:

Survey shows existing site conditions at the time of the survey. Any Site Plan or Grading Plan has been done by others.

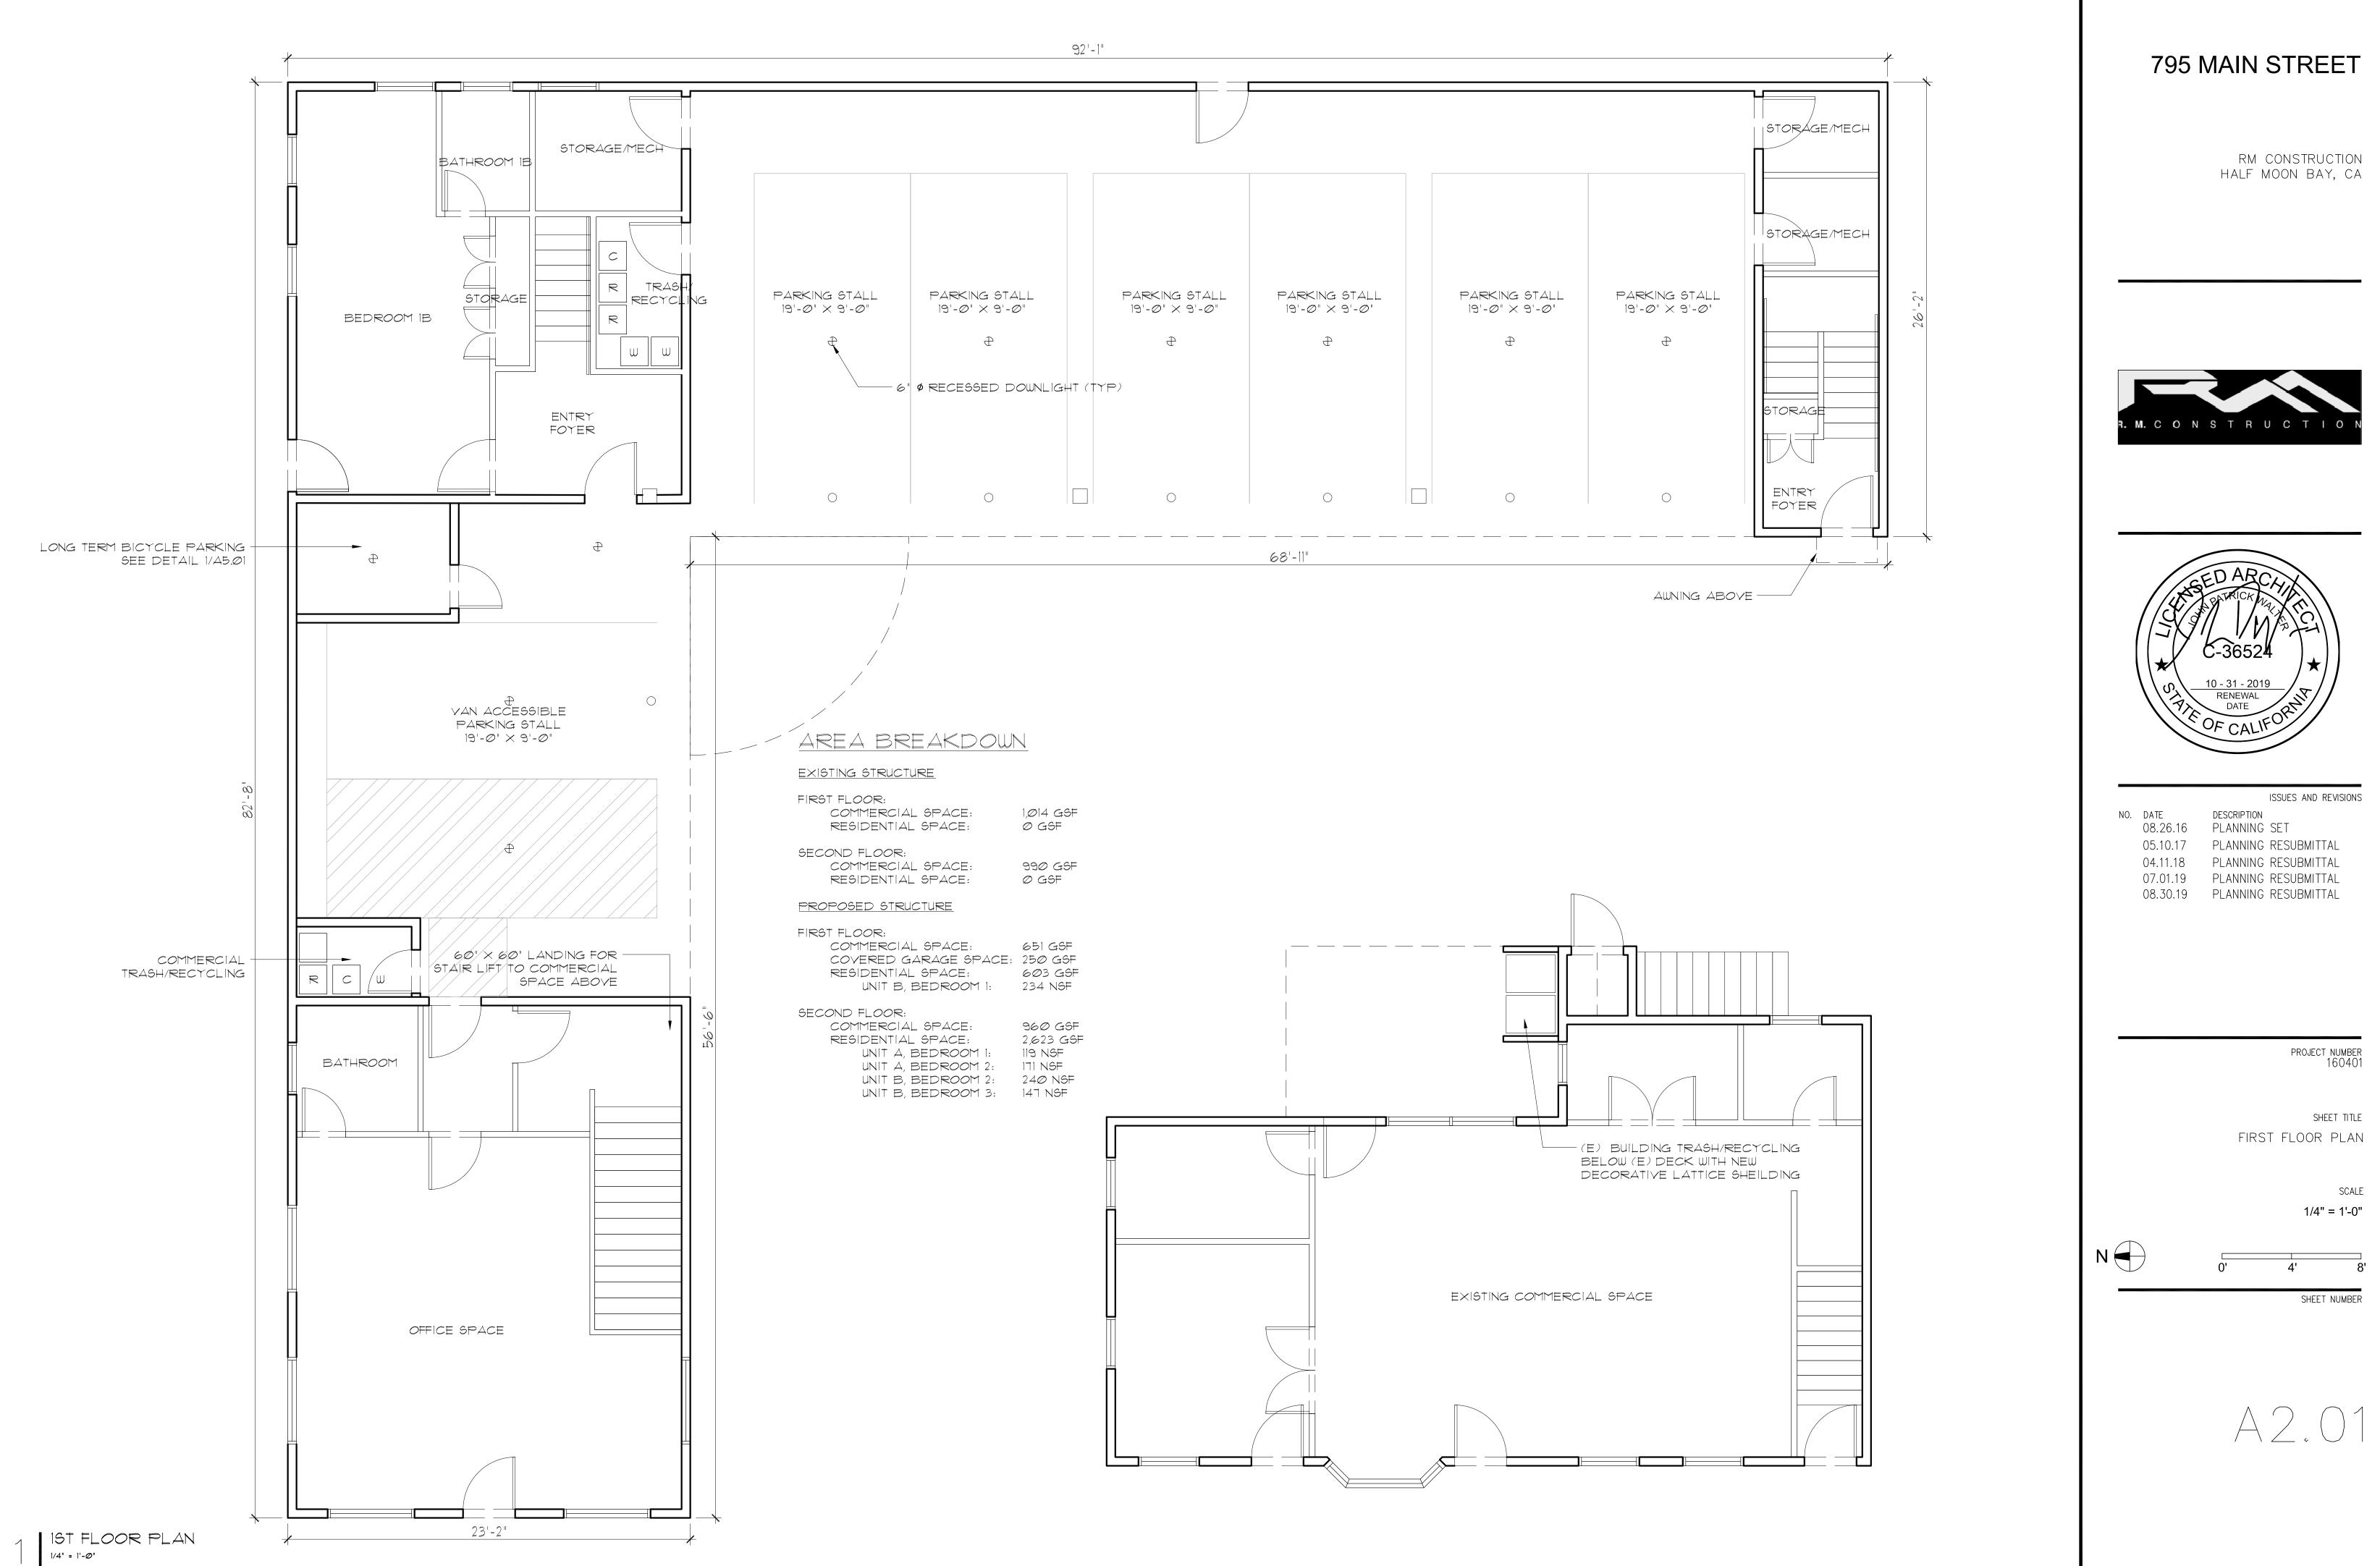


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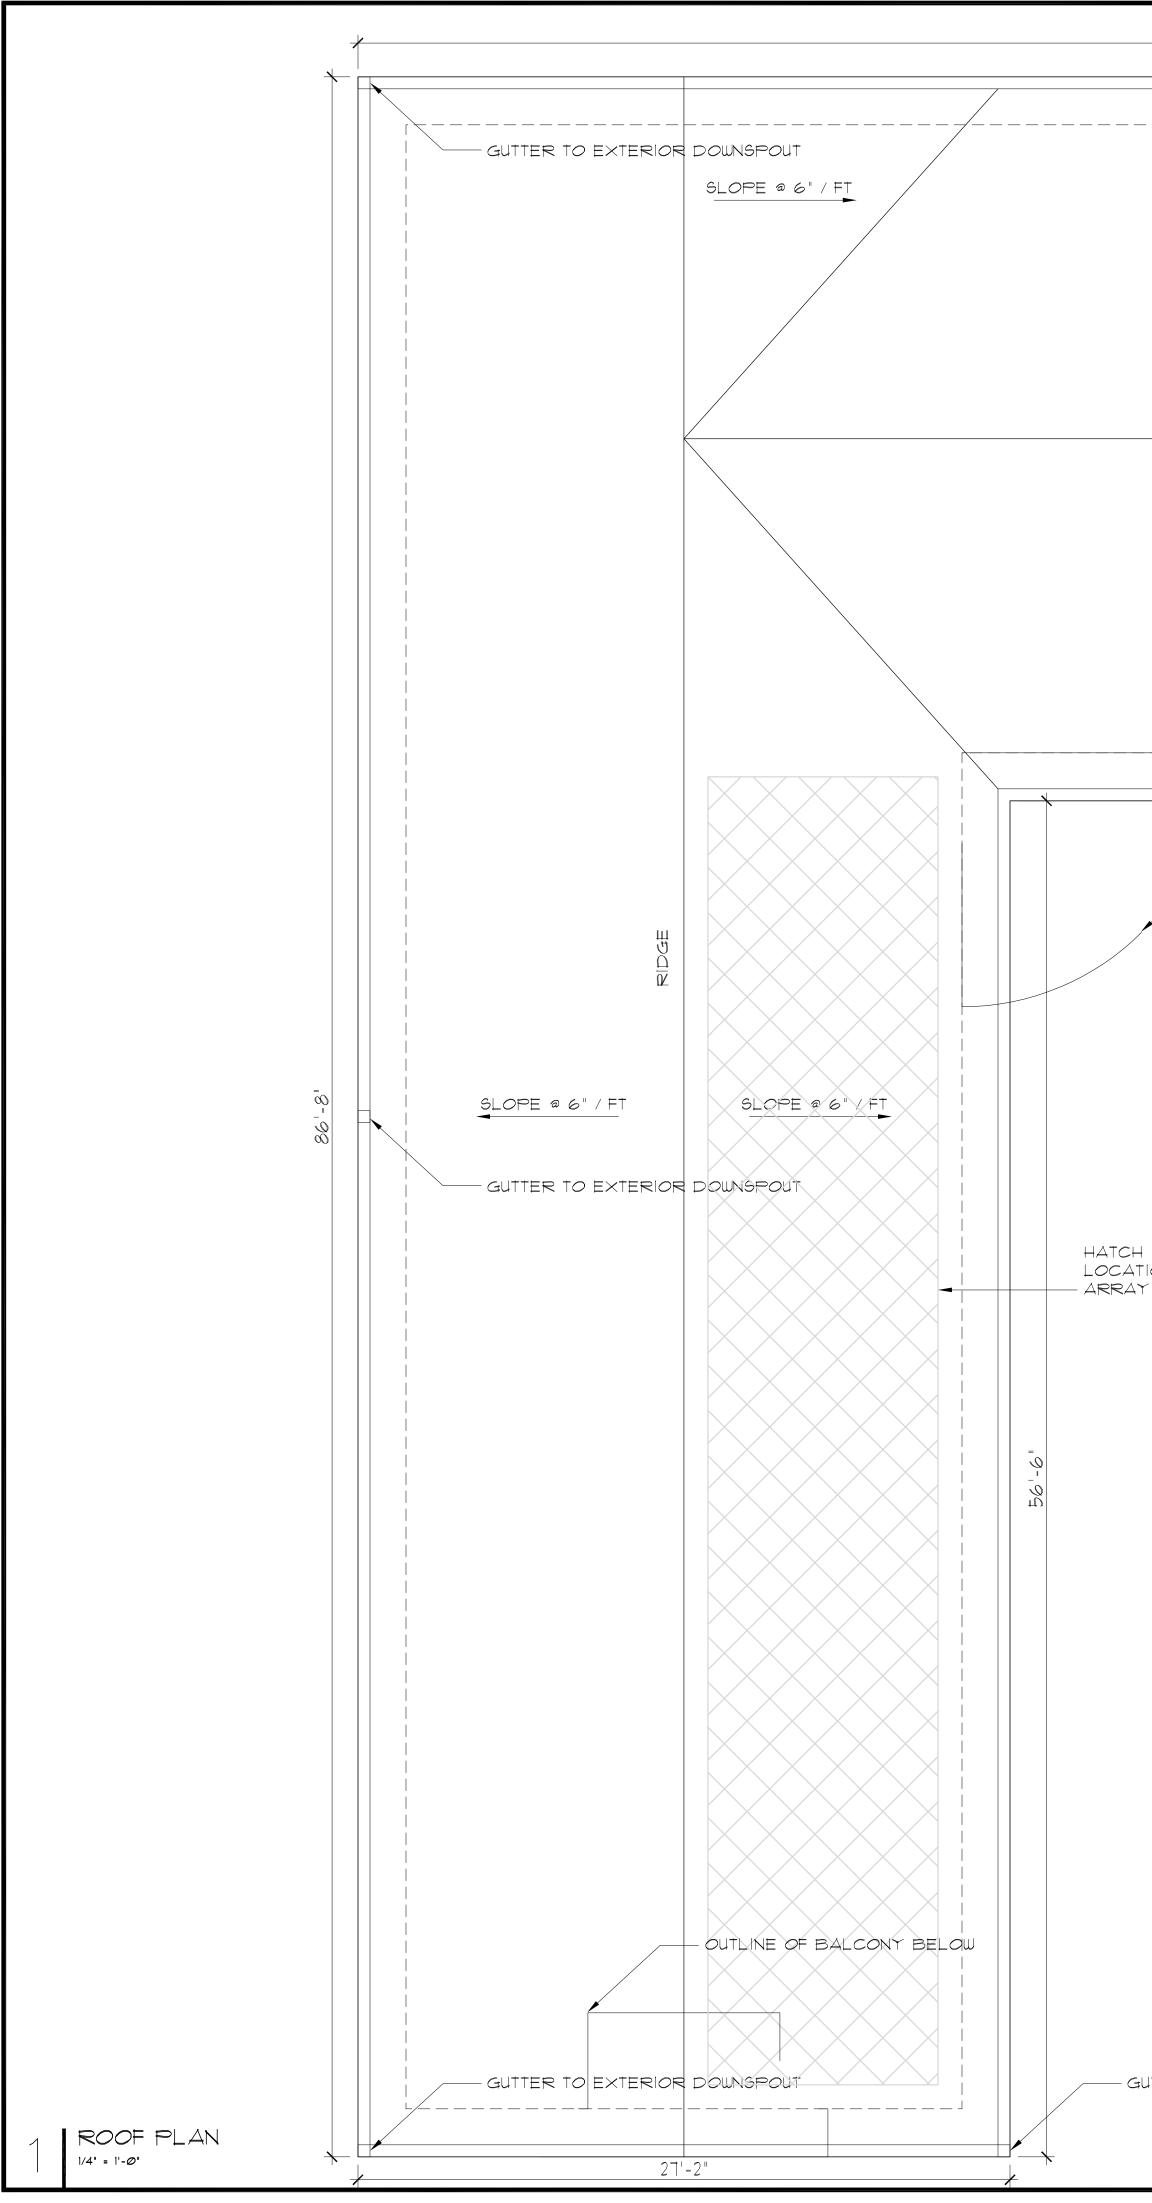
COMMERCIAL SPACE: RESIDENTIAL SPACE:	1,014 GSF 0 GSF
COND FLOOR: COMMERCIAL SPACE: RESIDENTIAL SPACE:	99Ø GSF Ø GSF
OPOSED STRUCTURE	
ST FLOOR:	

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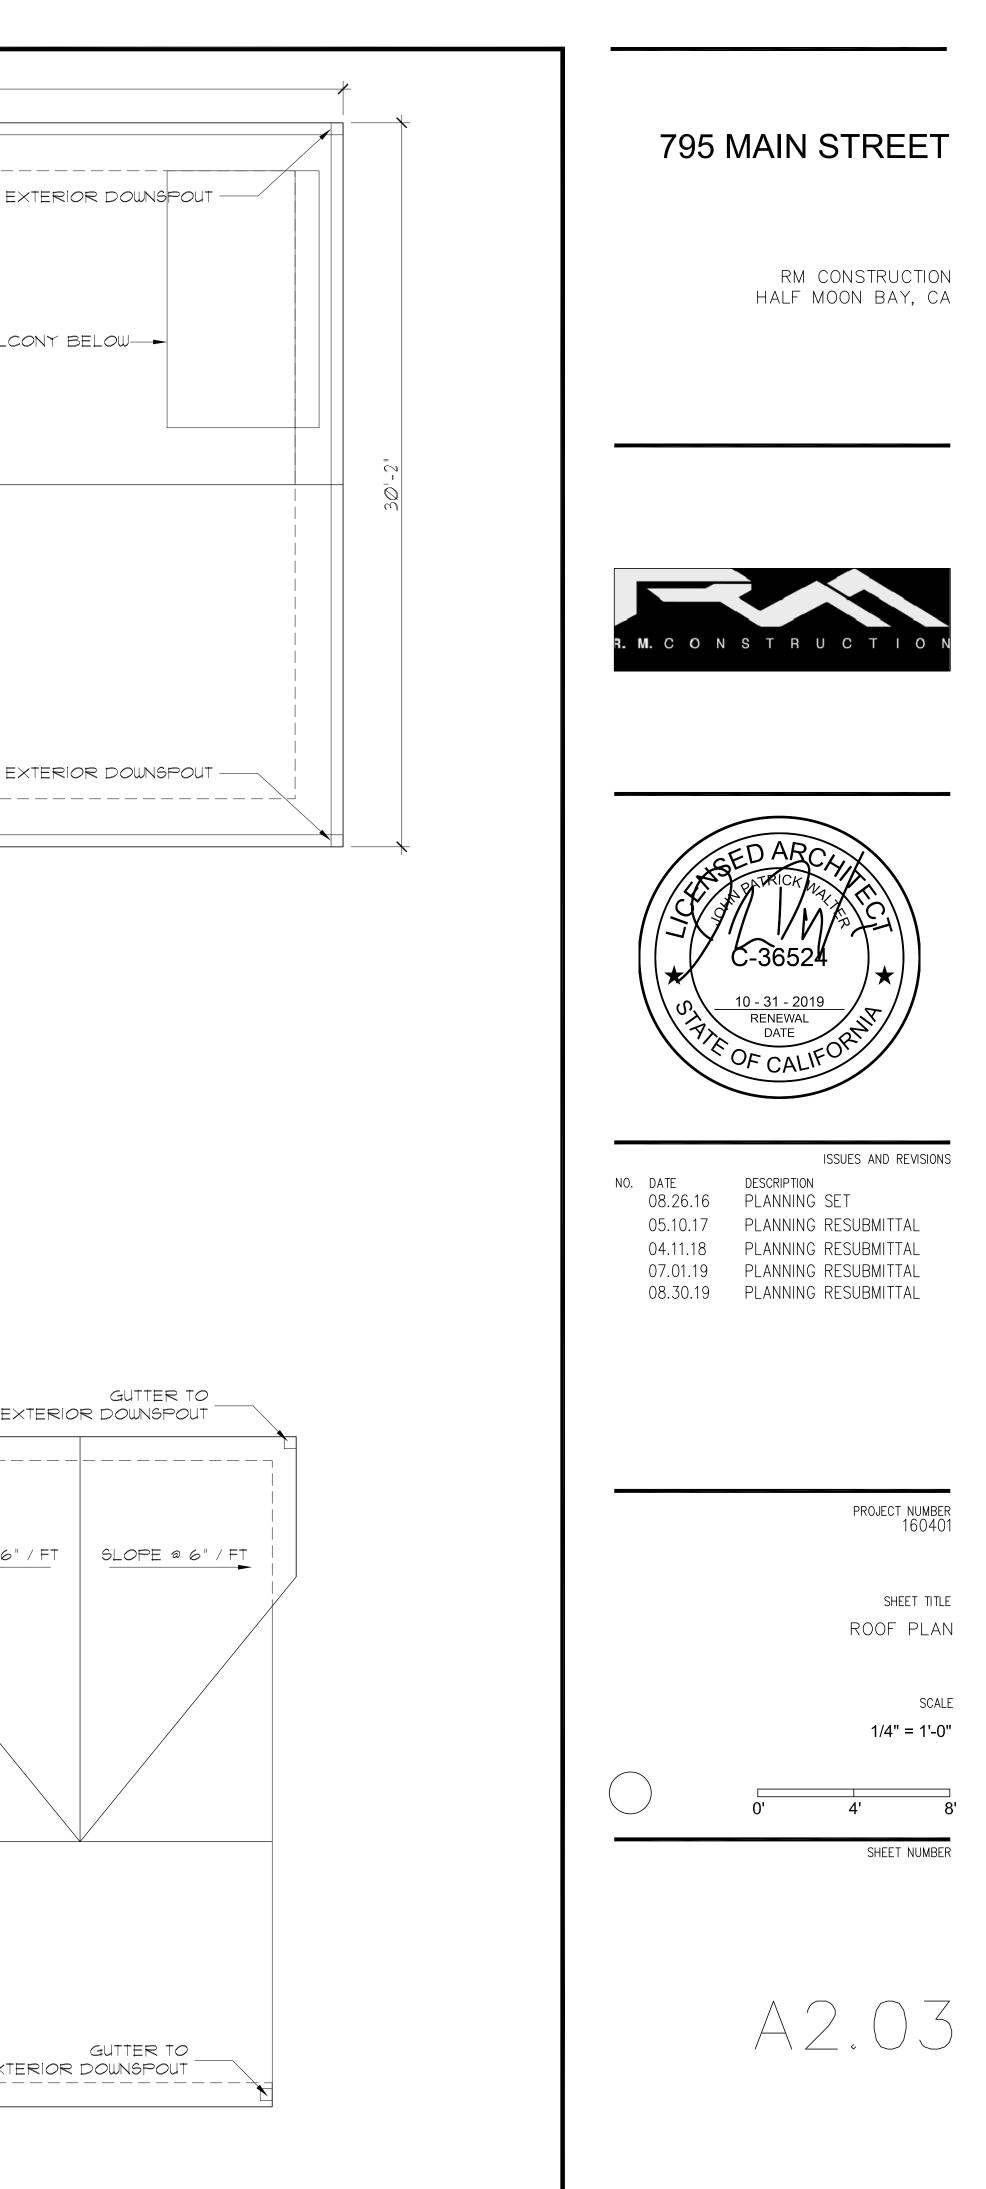
UNIT B, BEDROOM 1:	234 NS
COND FLOOR:	
COMMERCIAL SPACE:	96Ø C
RESIDENTIAL SPACE:	2,623 (
UNIT A, BEDROOM I:	119 NSF

UNIT	A,	BEDROOM	2:	1
UNIT	B,	BEDROOM	2:	2
UNIT	B,	BEDROOM	3:	1.




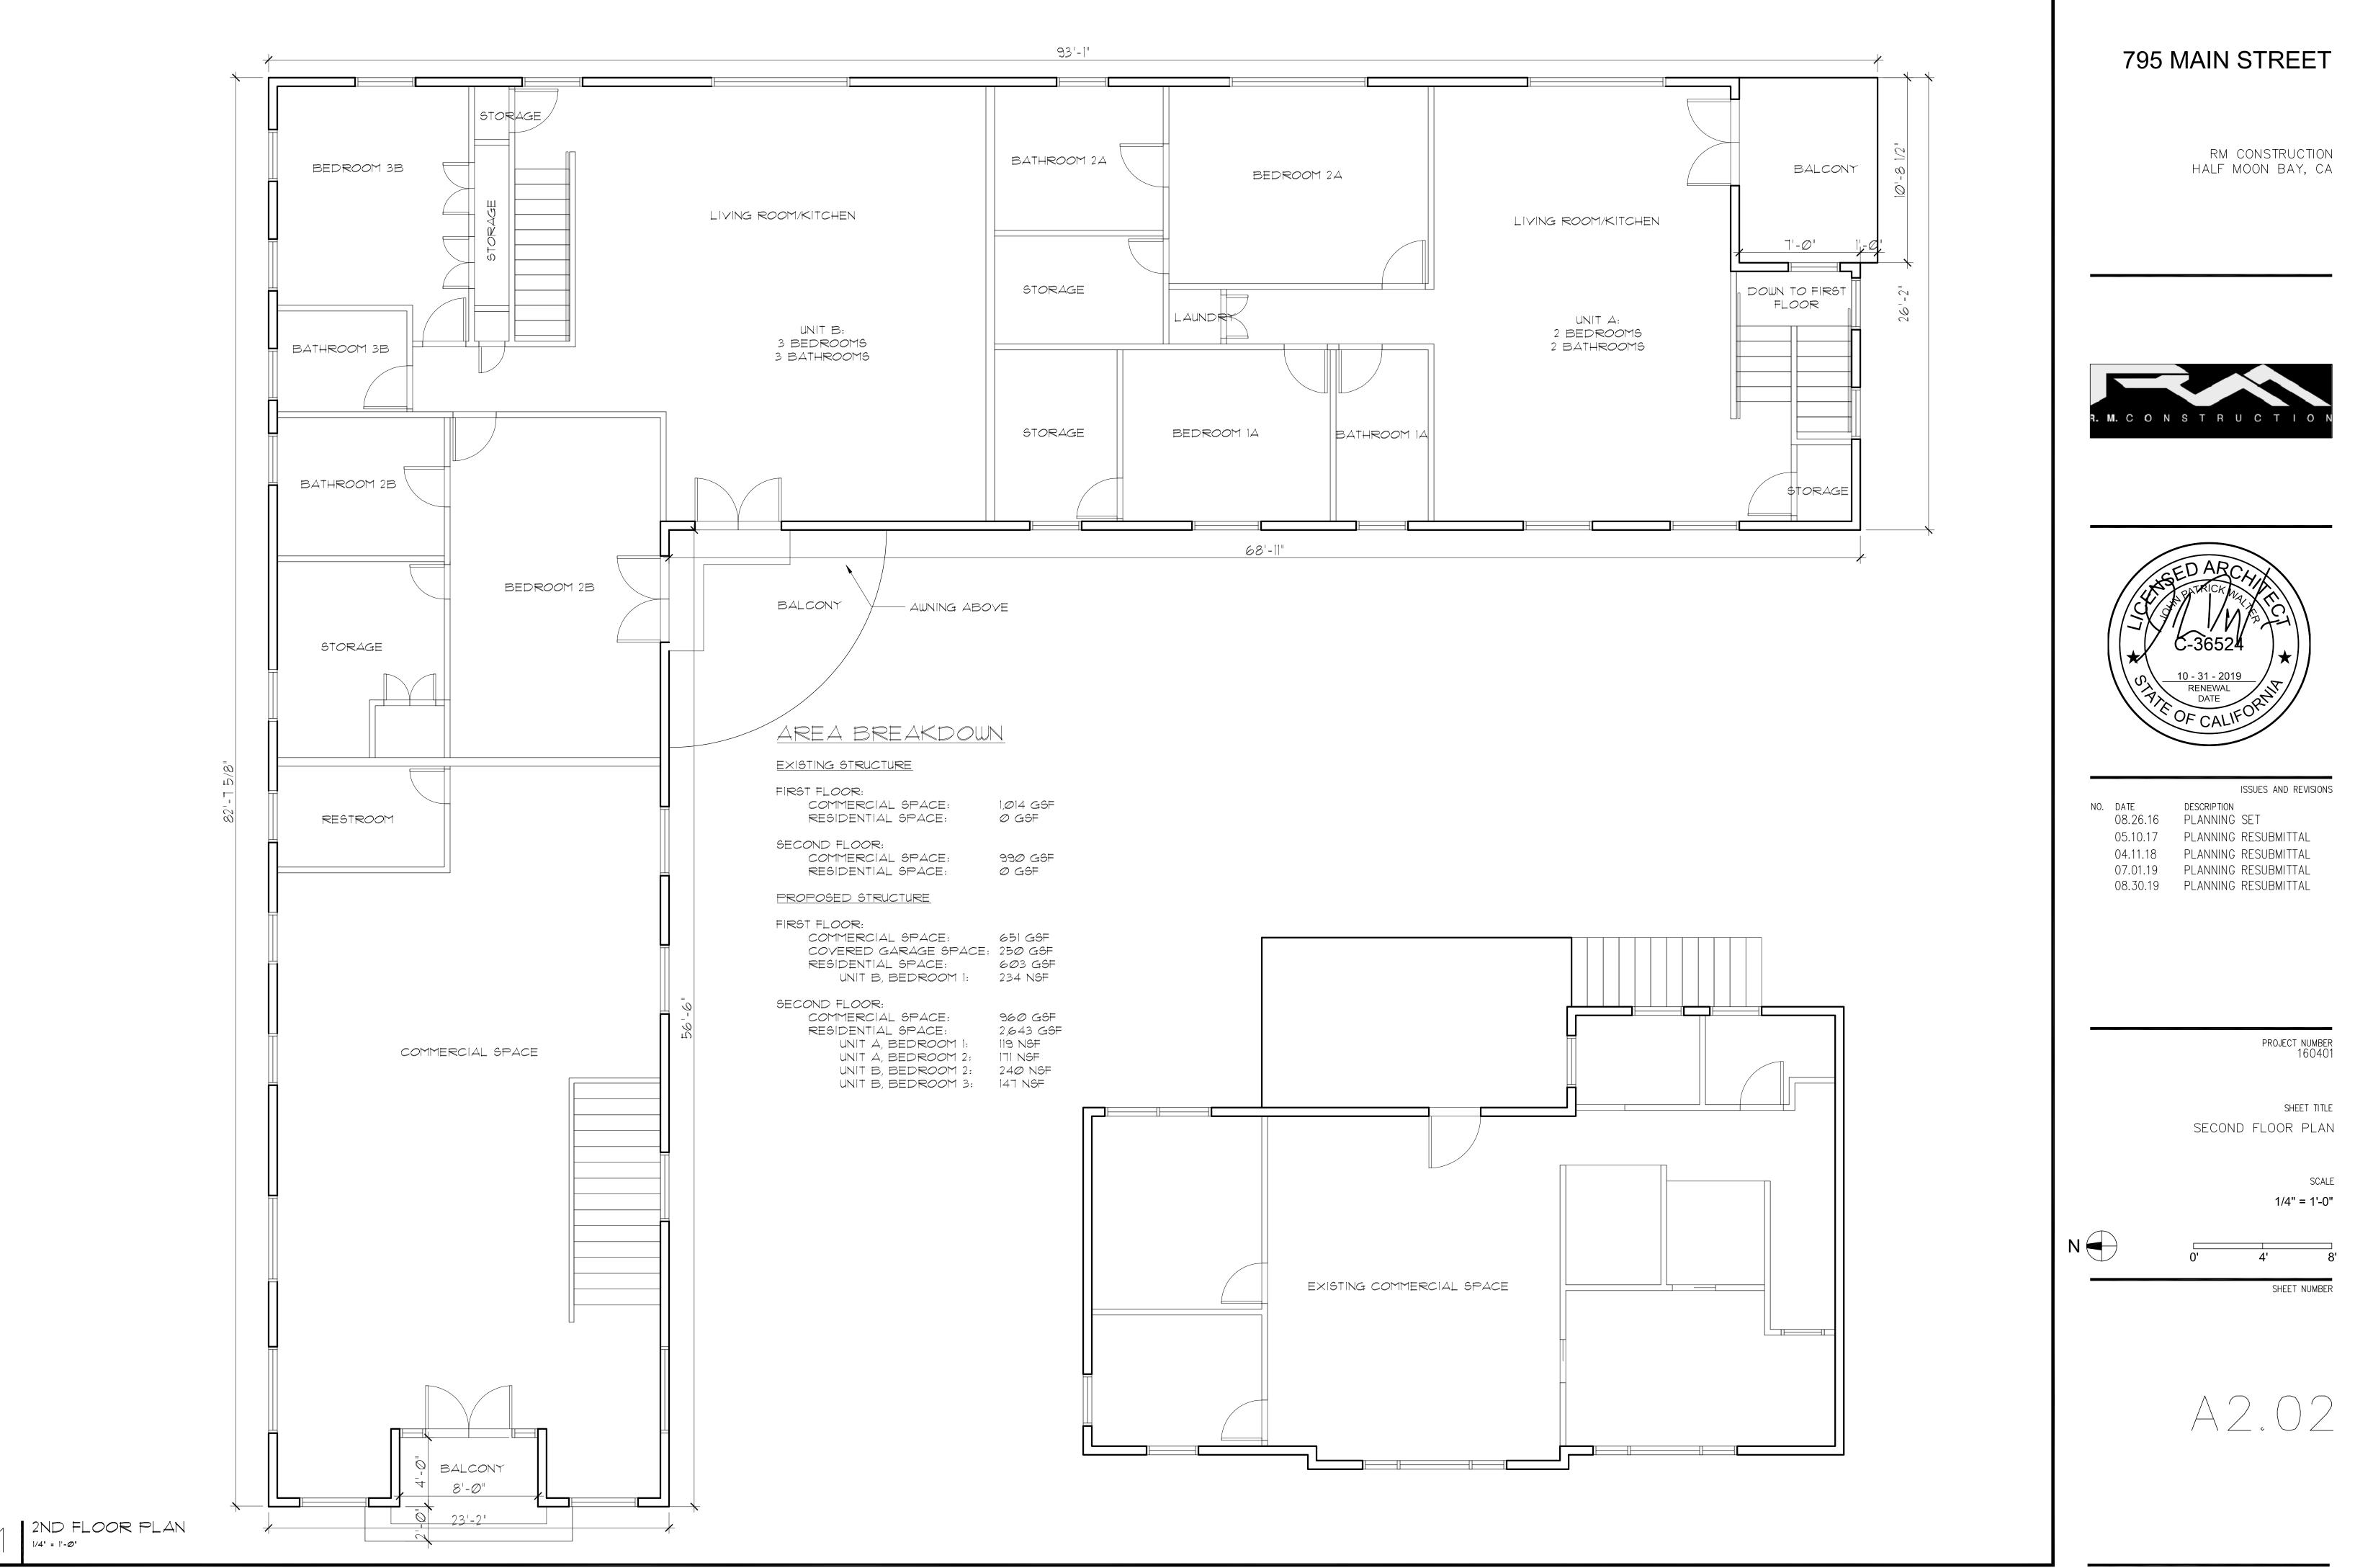

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- ASPHALT SHINGLE R*OO*F

MARVIN ULTIMATE GLIDER WINDOW WITH SIMULATED DIVIDED LIGHT (OR APPROVED EQUAL)

- INTEGRAL COLOR "HARDISHINGLE" SIDING

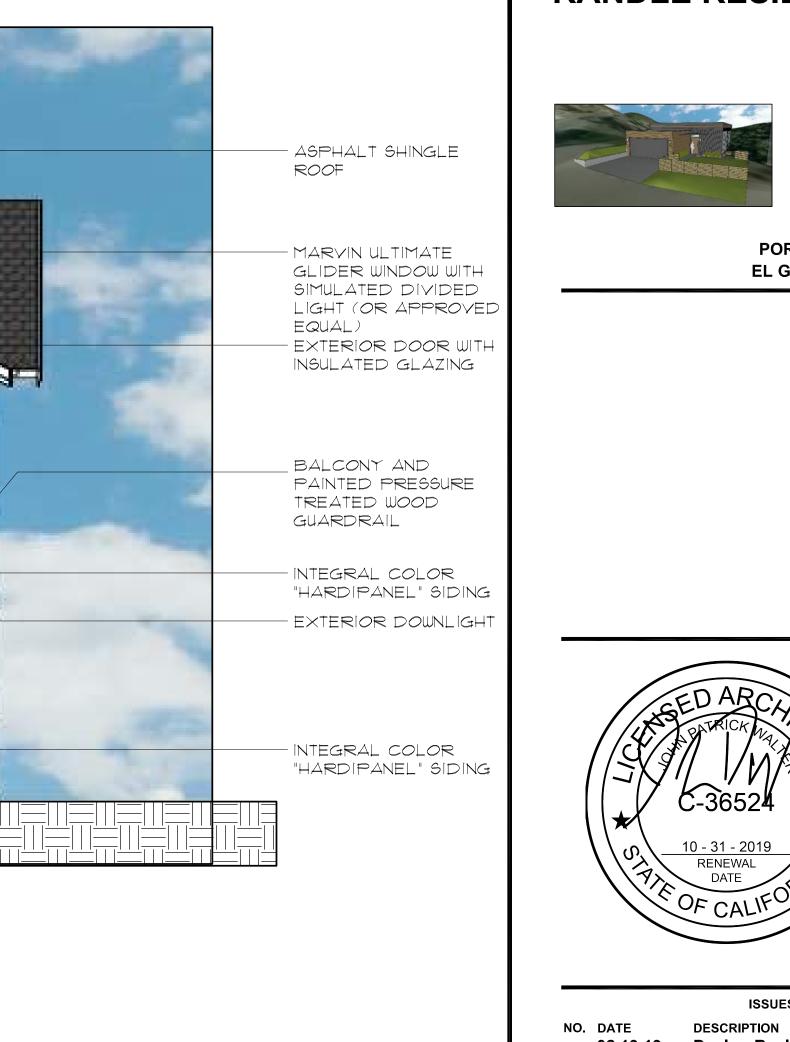BALCONY AND PAINTED PRESSURE TREATED WOODEN GUARDRAIL

EXTERIOR DOWNLIGHT

- MARVIN ULTIMATE DOUBLE HUNG WINDOW WITH SIMULATED DIVIDED LIGHT (OR APPROVED EQUAL)

INTEGRAL COLOR "HARDIPANEL" SIDING

RANDLE RESIDENCE

PORTION LOT 14 EL GRANADA, CA



ISSUES AND REVISIONS

02.19.19 Design Review-Draft 06.03.19 Design Review

PROJECT NUMBER 190001

SHEET TITLE PROPOSED ELEVATIONS

> SCALE 1/4" = 1'-0"

SHEET NUMBER





ASPHALT SHINGLE R*OO*F

MARVIN ULTIMATE GLIDER WINDOW WITH SIMULATED DIVIDED LIGHT (OR APPROVED EQUAL) - MARVIN NG ULTIMATE Double hung window WITH SIMULATED DIVIDED LIGHT (OR APPROVED EQUAL)

DECORATIVE SHUTTER AT WINDOW

INTEGRAL COLOR "HARDIPANEL" SIDING

- EXTERIOR DOWNLIGHT - MARVIN NG ULTIMATE DOUBLE HUNG WINDOW WITH SIMULATED DIVIDED LIGHT (OR APPROVED EQUAL - INTEGRAL COLOR "HARDIPANEL" SIDING - EXTERIOR DOOR WITH ACCENT PAINT, TYP

795 MAIN STREET

RM CONSTRUCTION HALF MOON BAY, CA





ISSUES AND REVISIONS

NO. DATE 05.10.17 04.11.18 07.01.19

DESCRIPTION 08.26.16 PLANNING SET PLANNING RESUBMITTAL PLANNING RESUBMITTAL PLANNING RESUBMITTAL 08.30.19 PLANNING RESUBMITTAL

PROJECT NUMBER 160401

SHEET TITLE PROPOSED ELEVATIONS

> SCALE 1/4" = 1'-0"

SHEET NUMBER



- ASPHALT SHINGLE ROOF

MARVIN ULTIMATE GLIDER WINDOW WITH SIMULATED DIVIDED LIGHT (OR APPROVED EQUAL)

- MARVIN NG ULTIMATE DOUBLE HUNG WINDOW WITH SIMULATED DIVIDED LIGHT (OR APPROVED EQUAL)

INTEGRAL COLOR "HARDISHINGLE" SIDING

BALCONY AND PAINTED WOODEN GUARDRAIL

EXTERIOR DOWNLIGHT

EXTERIOR DOOR WITH ACCENT PAINT, TYP

- INTEGRAL COLOR "HARDIPANEL" SIDING

- EXTERIOR WALL SCONCE



- ASPHALT SHINGLE Roof

PAINT EXISTING SIDING TO MATCH UPPER OF PROPOSED BUILDING


- NEW HORIZONTAL WHITE TRIM TO MATCH PROPOSED BUILDING

- PAINT EXISTING SIDING TO MATCH LOWER BAND OF PROPOSED BUILDING

795 MAIN STREET

RM CONSTRUCTION HALF MOON BAY, CA



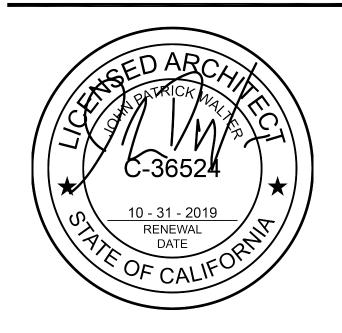

ISSUES AND REVISIONS

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PROJECT NUMBER 160401

SHEET TITLE PROPOSED ELEVATIONS WITH EXISTING BUILDING

> SCALE 1/4" = 1'-0"

SHEET NUMBER



- EXISTING ASPHALT SHINGLE ROOF

EXISTING CLEAR INSULATED GLAZING UNIT WITH DIVIDED LIGHTS. TRIM TO RECEIVE NEW WHITE PAINT.

- PAINT EXISTING SIDING TO MATCH UPPER BAND OF PROPOSED BUILDING NEW HORIZONTAL WHITE TRIM TO MATCH PROPOSED BUILDING

PAINT EXISTING SIDING TO MATCH LOWER BAND OF PROPOSED BUILDING DEMOLISH EXISTING AWNING AND LIGHT ABOVE DOORS

EXTERIOR DOOR TO RECEIVE NEW ACCENT PAINT, TYP EXISTING BRICK TO

REMAIN

NEW EXTERIOR WALL SCONCE



NTS

VIEW FROM MAIN STREET - SOUTH (PROPOSED)








795 MAIN STREET

RM CONSTRUCTION HALF MOON BAY, CA



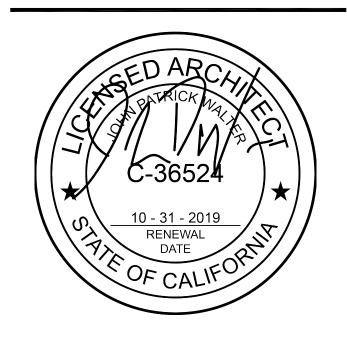

ISSUES AND REVISIONS

NO. DATE 04.11.18

DESCRIPTION 08.26.16 PLANNING SET 05.10.17 PLANNING RESUBMITTAL PLANNING RESUBMITTAL 07.01.19 PLANNING RESUBMITTAL 08.30.19 PLANNING RESUBMITTAL

PROJECT NUMBER 160401

SHEET TITLE PERSPECTIVES

> SCALE NTS


SHEET NUMBER



$2" \times 2"$ Stained REDWOOD LATTICE

- OFFSET STAINED REDWOOD PANELING

PAINTED REDWOOD SUPPORT POSTS, AS REQUIRED

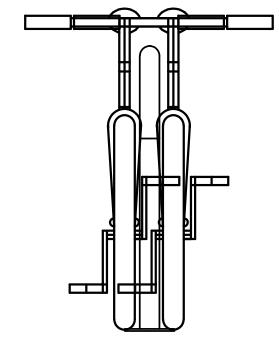

DERO WALL RACK

 \bigcirc

NTS

1 GOOD NEIGHBOR FENCE DETAIL NTS

 \times


8


DERO HOOP RACK HEAVY DUTY NTS


2'-Ø"

 $\overline{}$


TRELLIS OUTRIGGER DETAIL 1 1/2" = 1'-Ø"

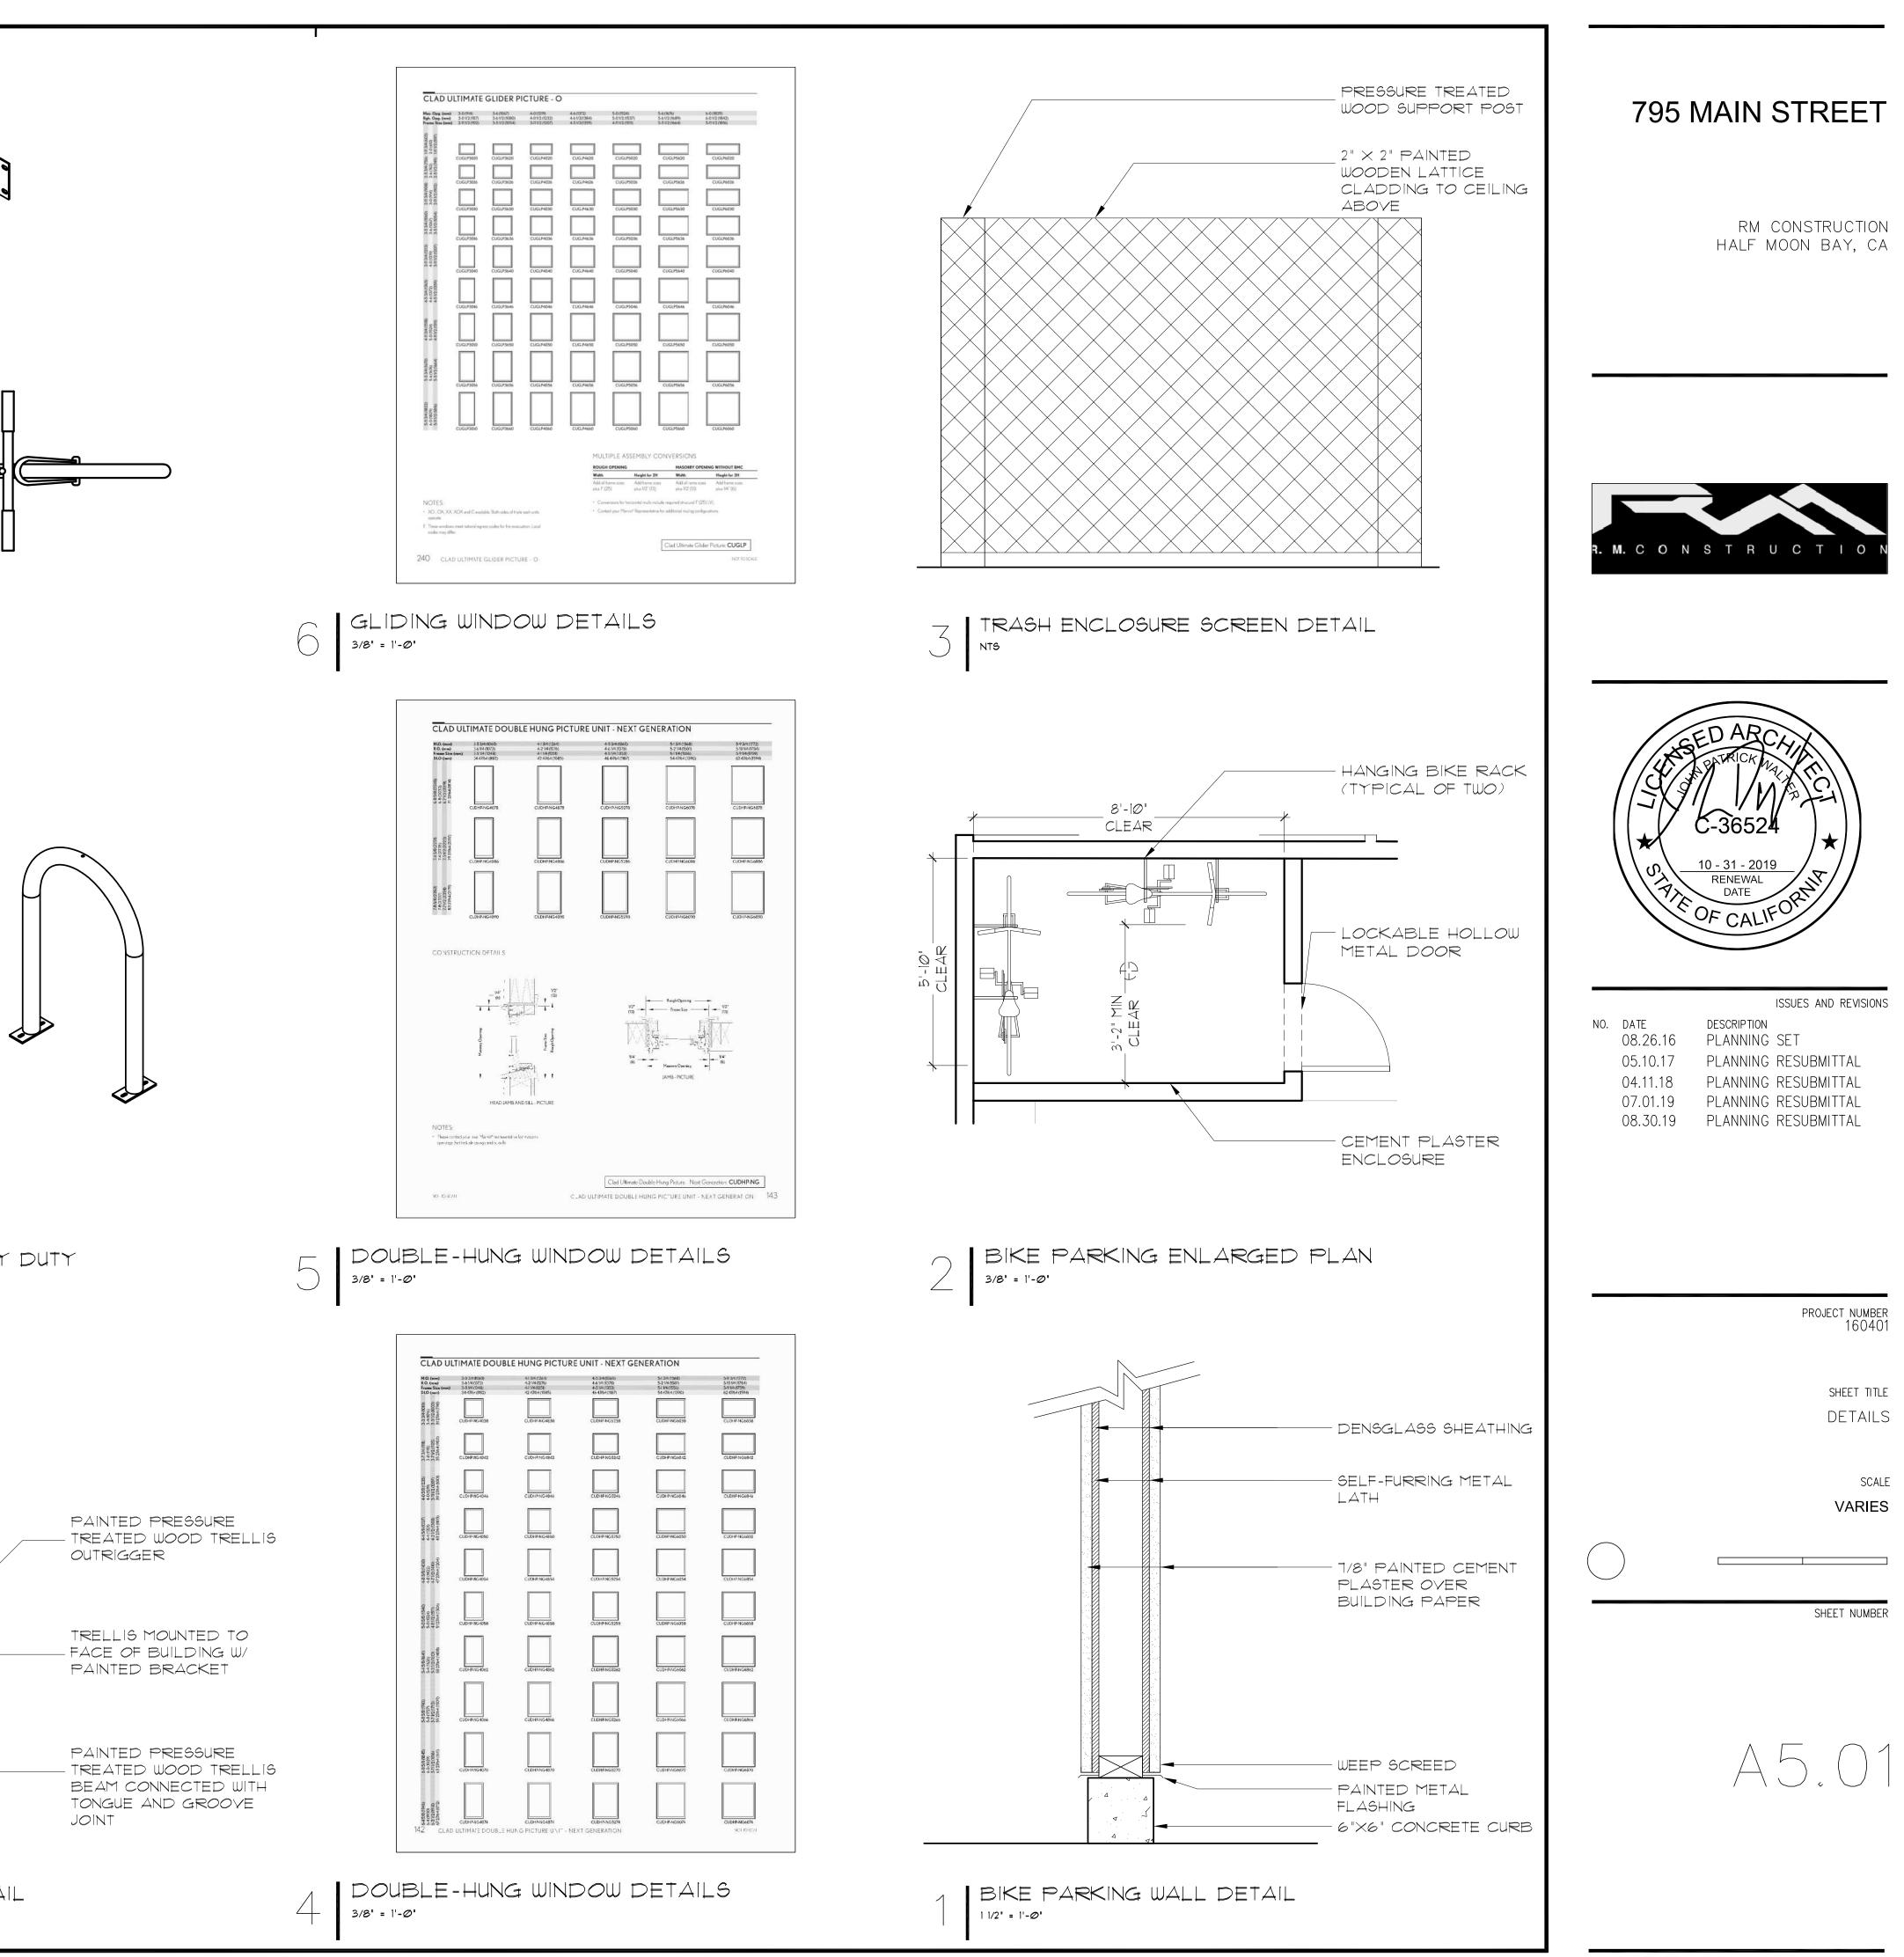

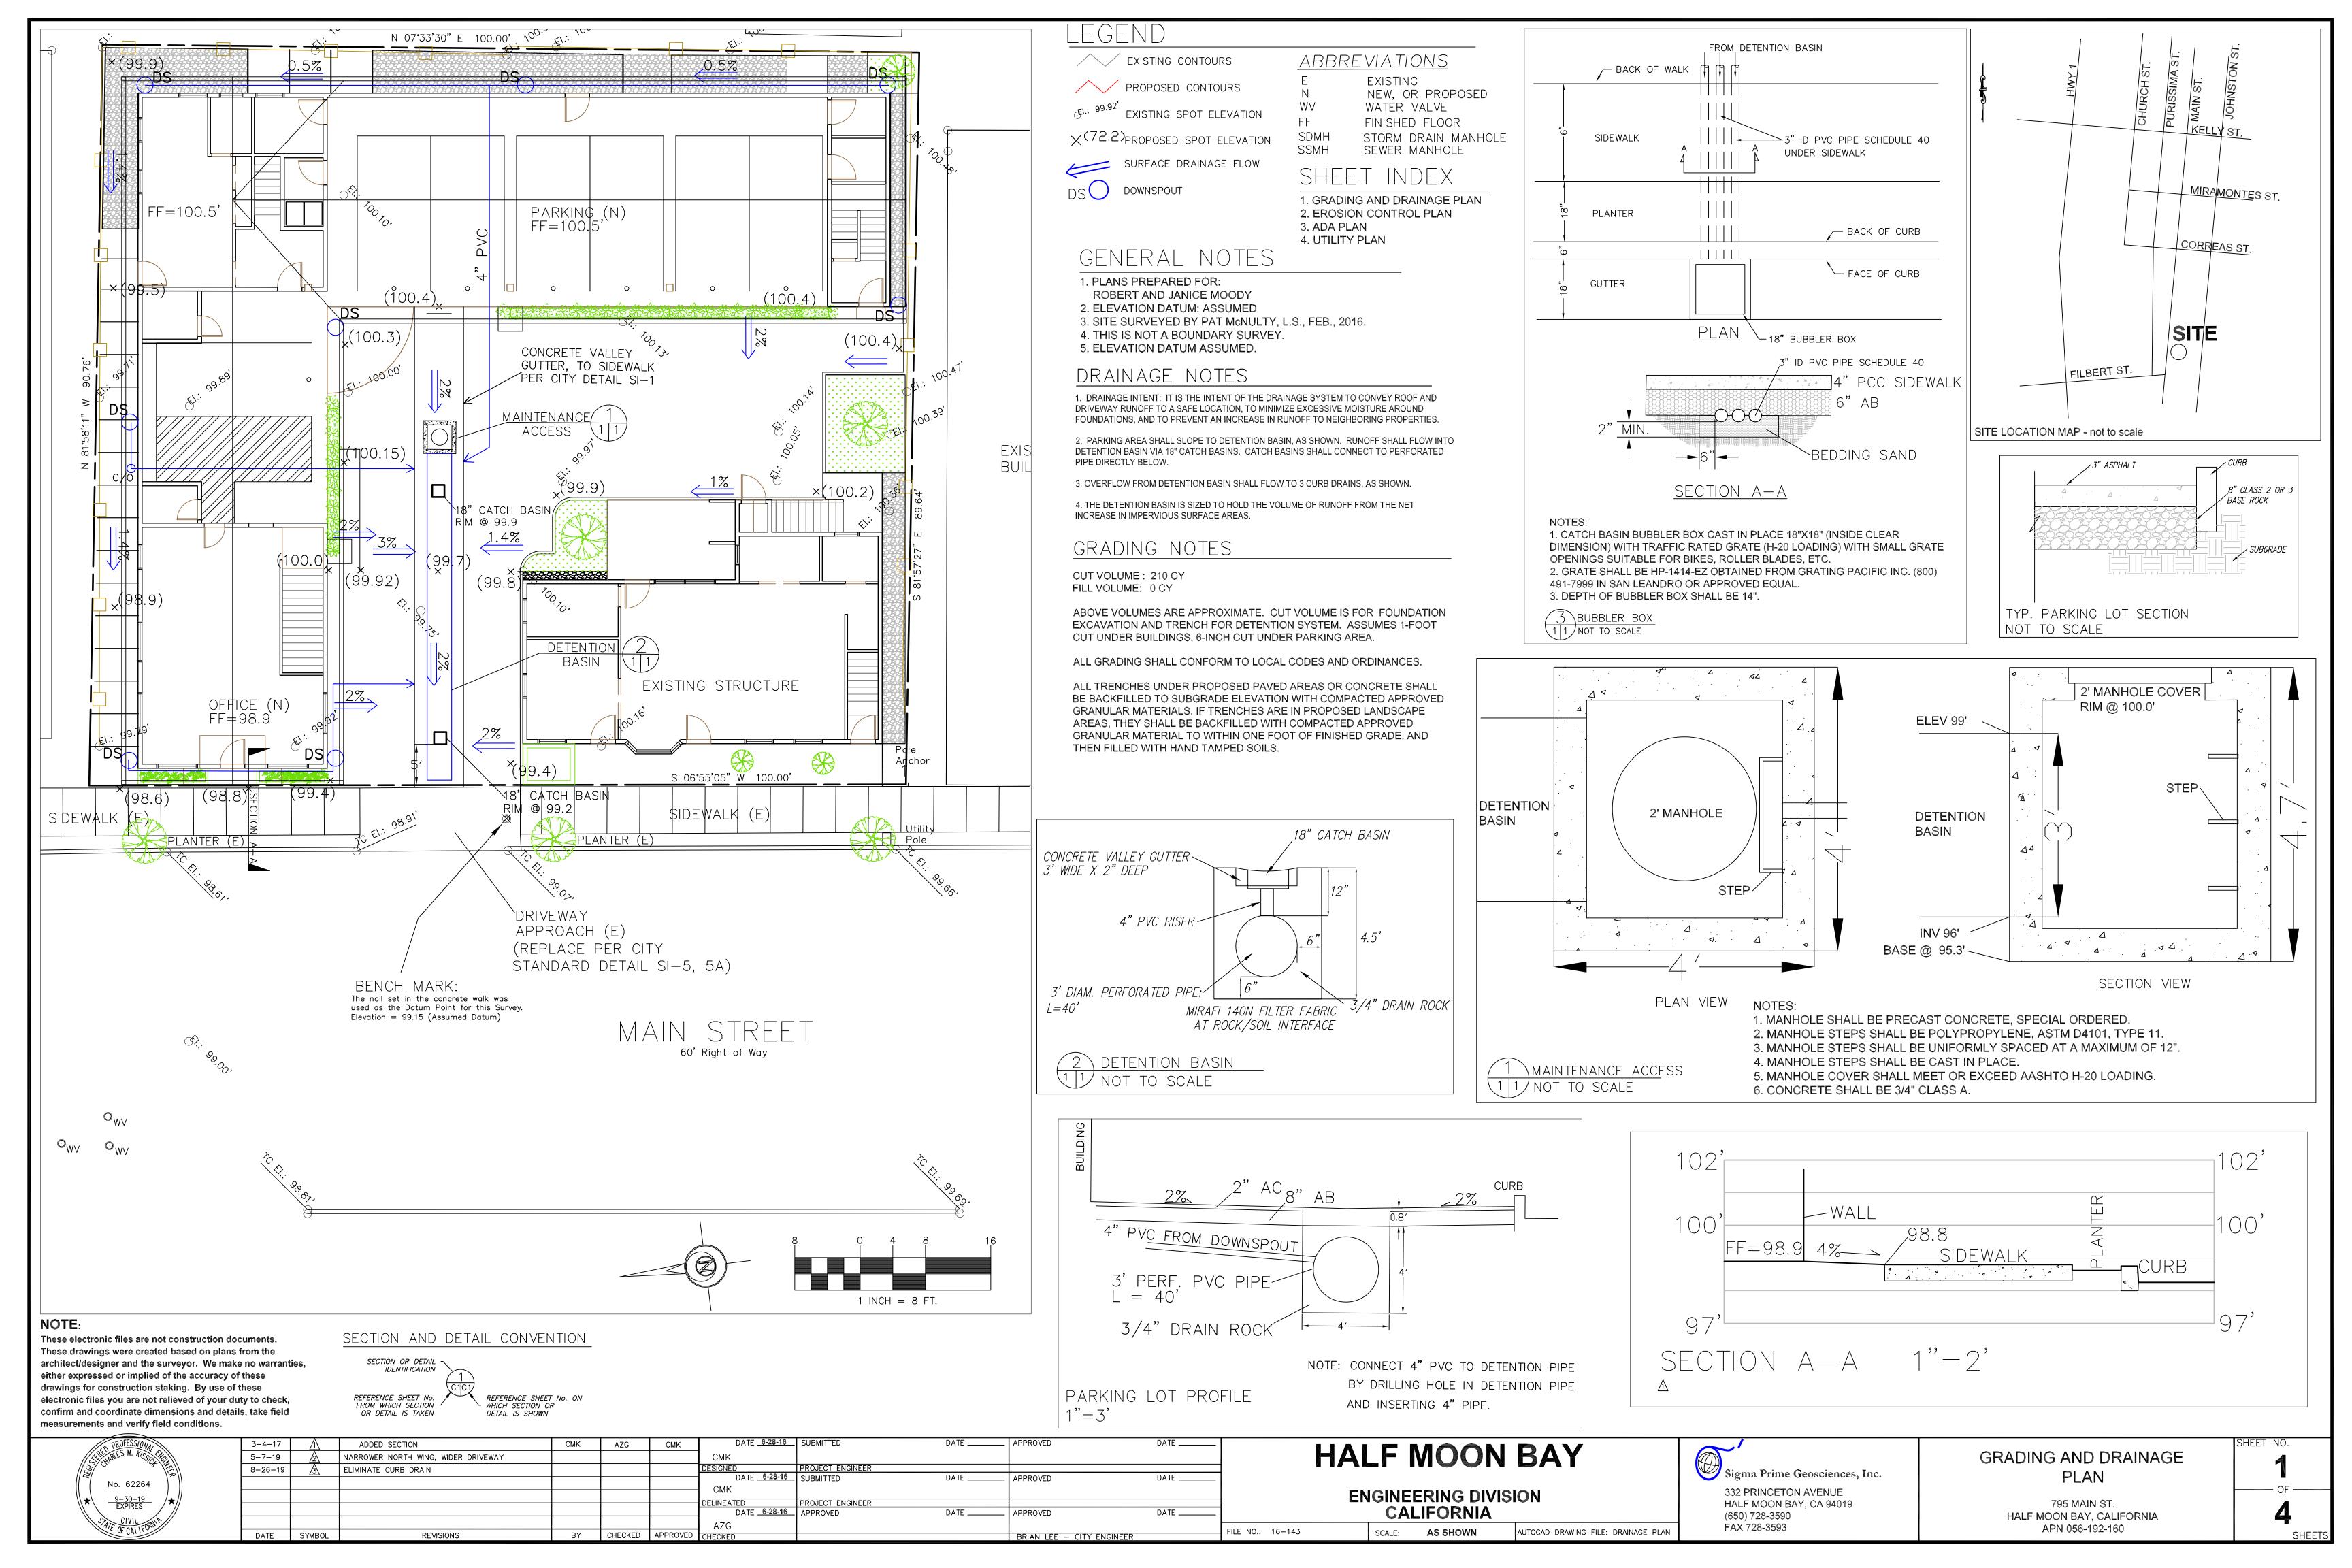

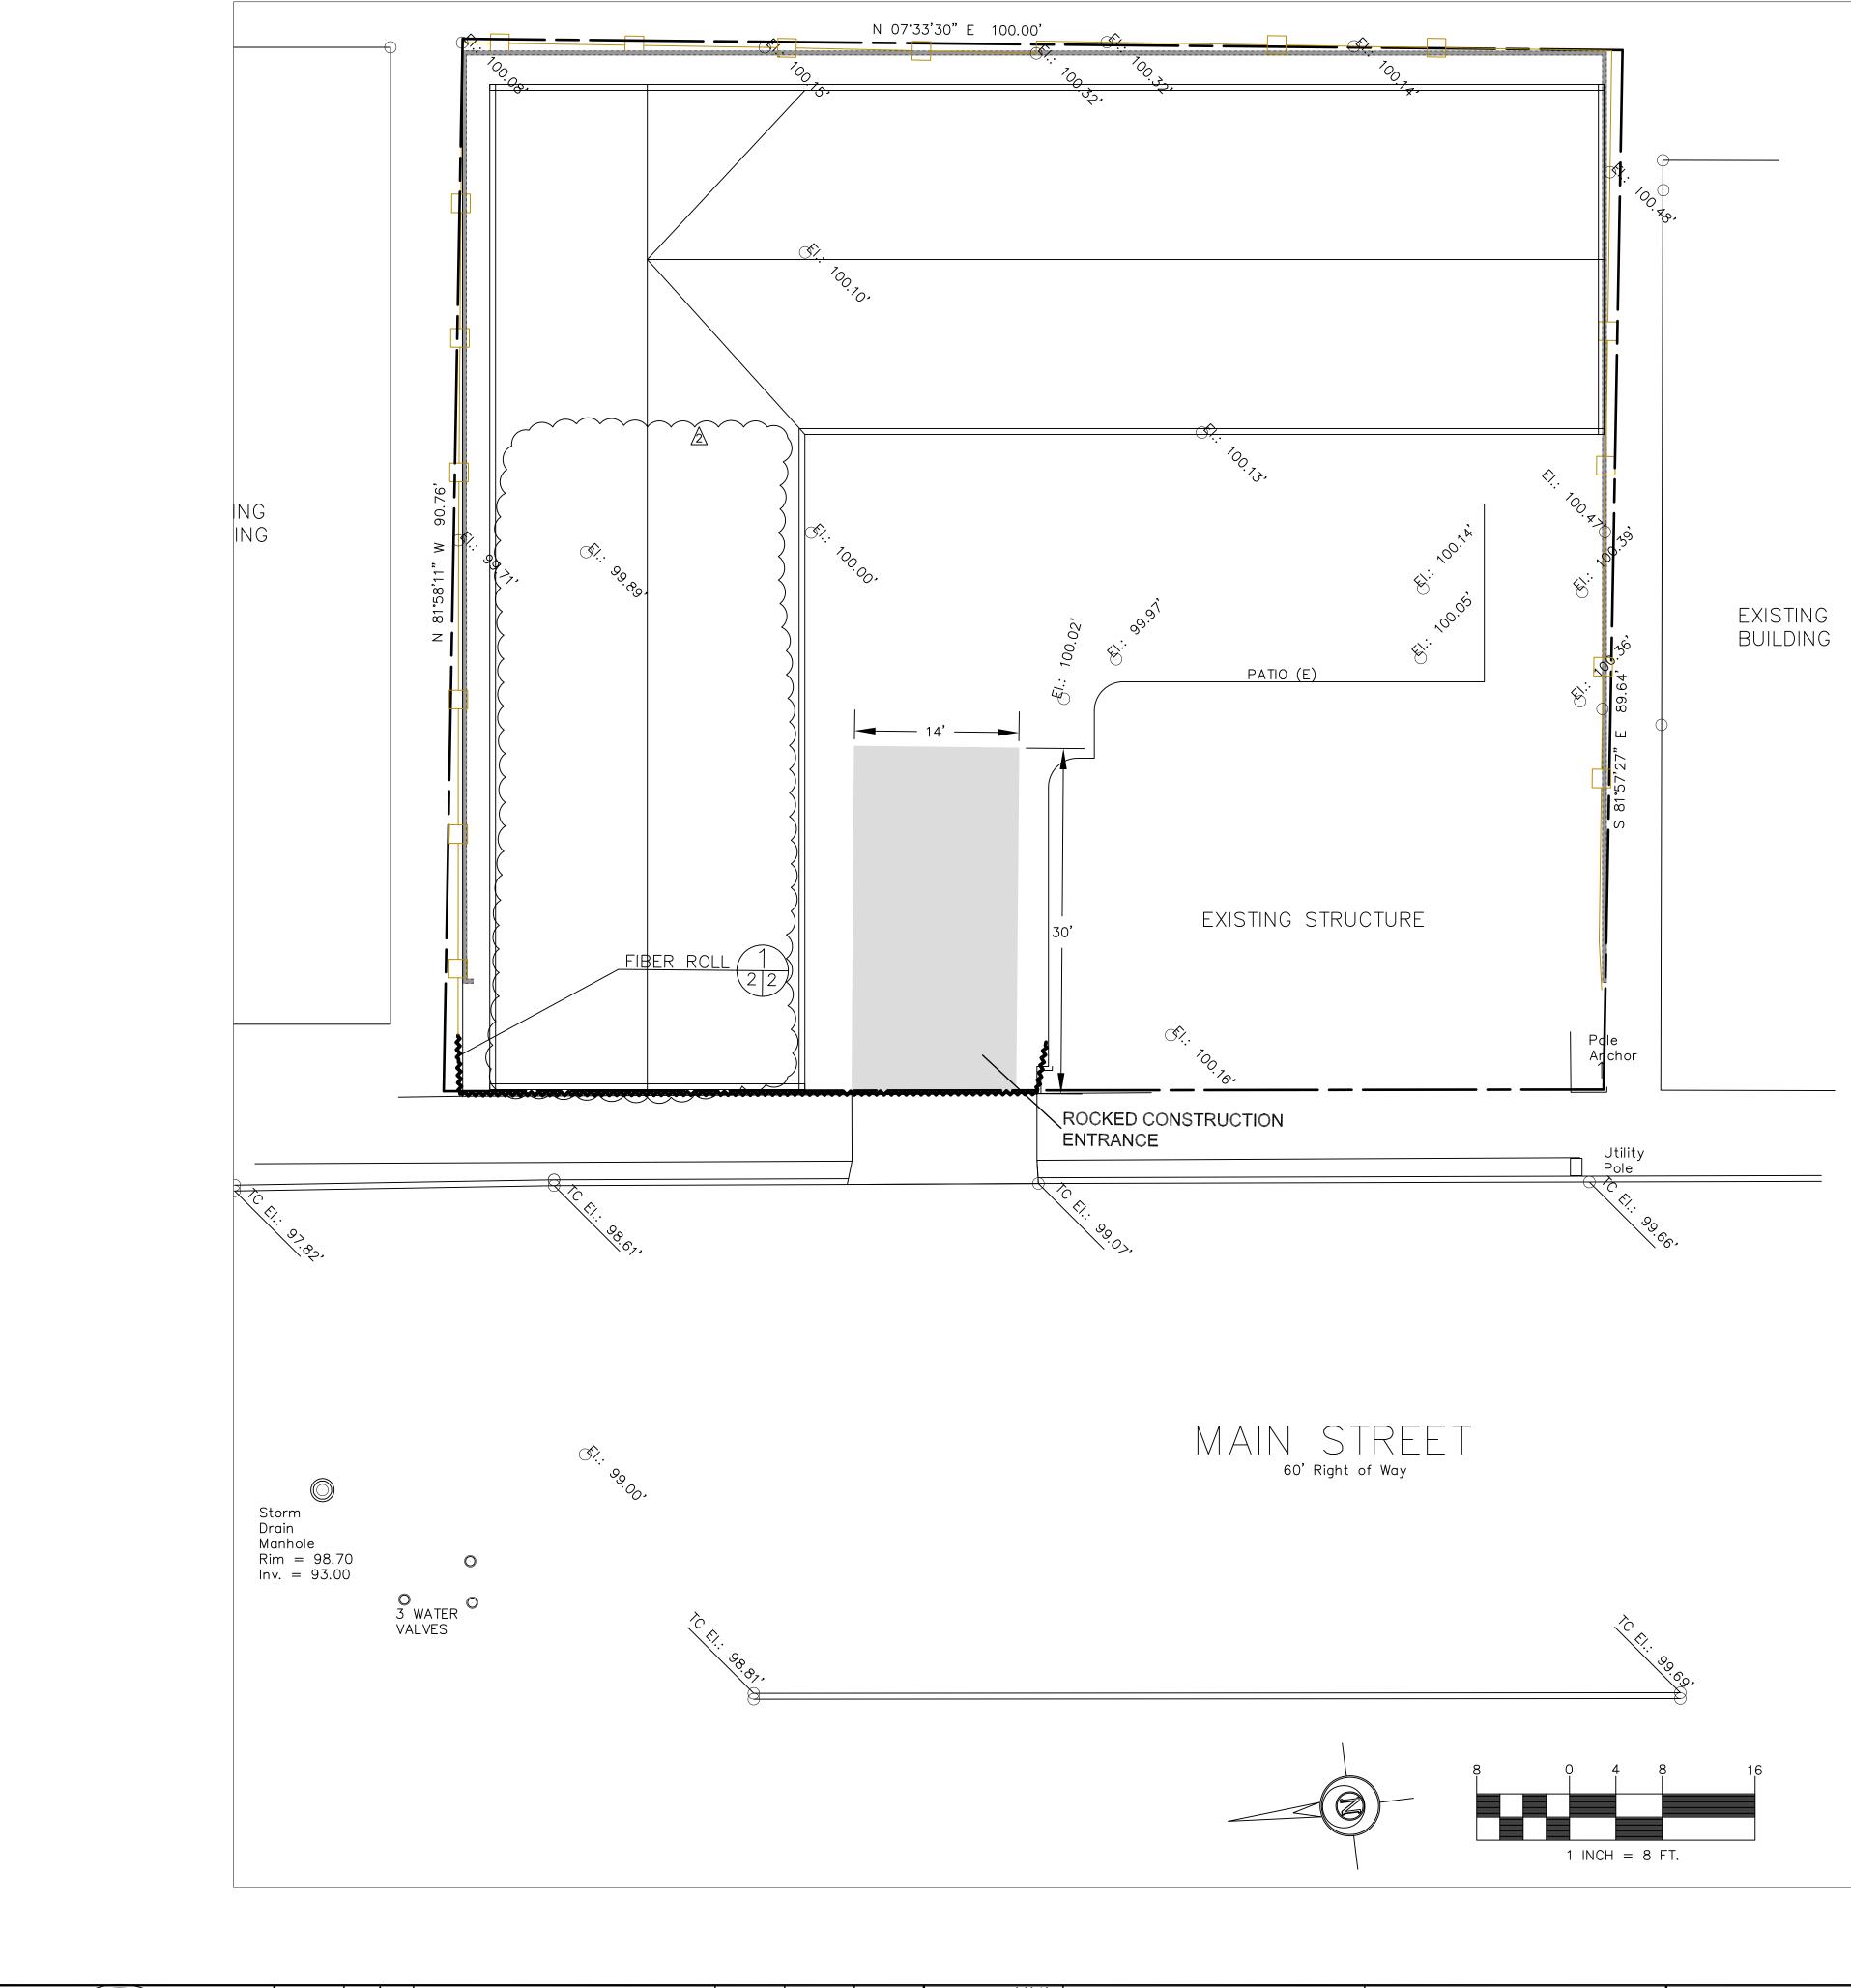

PROFESSIONAL	3-4-17	A	ADDED SECTION				DATE <u>6-28-16</u>	SUBMITTED
LES M. KISSEN	5-7-19	A	NARROWER NORTH WING, WIDER DRIVEWAY				СМК	
S CHIN OF CHINA							DESIGNED	PROJECT E
							DATE <u>6-28-16</u>	SUBMITTED
No. 62264							СМК	
	1							
$\left(\star \right) = \frac{9-30-19}{\text{EXPIRES}} $								PROJECT E
							DATE <u>6-28-16</u>	APPROVED
STATE CIVIL							AZG	
12 OF CALIFO	DATE	SYMBOL	REVISIONS	BY	CHECKED	APPROVED	CHECKED	

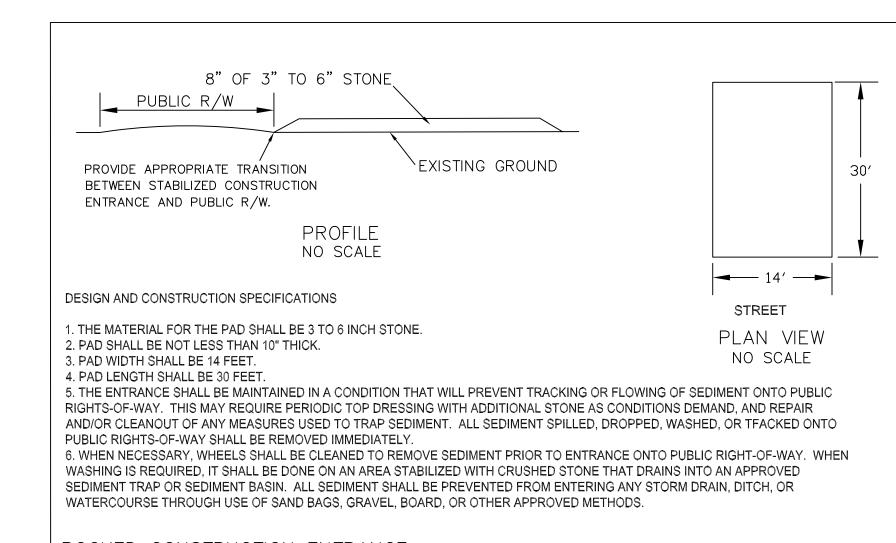

DATE _____ DATE _____ _ APPROVED ED HALF MOON BAY <u>CT ENGINEER</u> ITED DATE ______ APPROVED DATE _____ ENGINEERING DIVISION CALIFORNIA T ENGINEER VED _ APPROVED DATE ___ DATE ____ SCALE: AS SHOWN AUTOCAD DRAWING FILE: DRAINAGE PLAN FILE NO.: 16-143 BRIAN LEE - CITY ENGINEER

ROCKED CONSTRUCTION ENTRANCE

EROSION CONTROL NOTES


FIBER ROLL: INSTALL AT LOCATIONS SHOWN. AFIX AS SHOWN IN DETAIL 1.

1. FOR CONSTRUCTION DURING DRY SEASON, ALL EXPOSED SURFACES SHALL BE WETTED PERIODICALLY TO PREVENT SIGNIFICANT DUST. 2. ALL EXPOSED SOIL SHALL BE A RATE OF 2 TONS/ACRE. PROTECTED FROM EROSION AT ALL TIMES. SUCH PROTECTION SHALL CONSIST OF JUTE MATTING ON SLOPES.

3. ALL STOCKPILED SOIL SHALL BE CO∨ERED DURING PERIODS OF RAIN. 4. BEFORE COMPLETION OF PROJECT ALL EXPOSED OR

DISTURBED SURFACES SHALL BE PERMANENTLY PROTECTED FROM EROSION.

5. AREAS TO RECIEVE NATURAL VEGETATION SHALL BE SEEDED PRIOR TO DCT 15 WITH 75# PER ACRE DF ANNUAL RYEGRASS DR APPROVED SUBSTITUTE, AS PER LANDSCAPE PLAN.

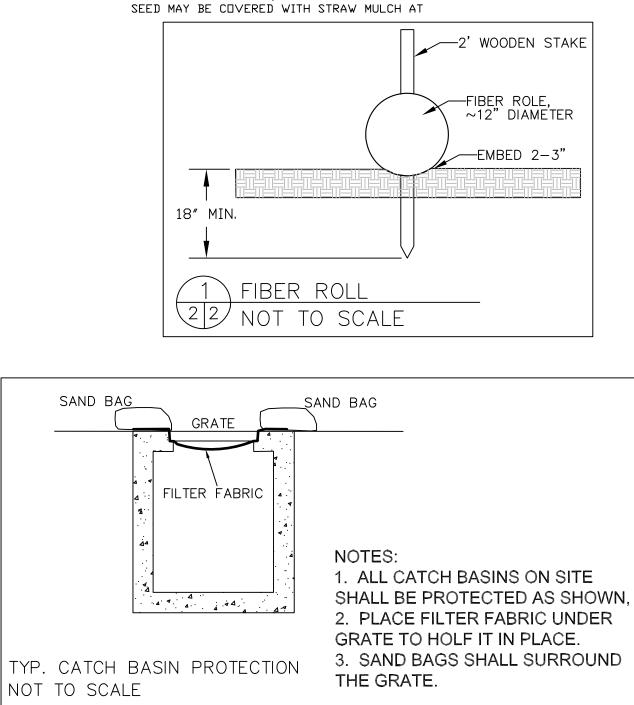

NOTE:


These electronic files are not construction documents. These drawings were created based on plans from the architect/designer and the surveyor. We make no warranties, either expressed or implied of the accuracy of these drawings for construction staking. By use of these electronic files you are not relieved of your duty to check, confirm and coordinate dimensions and details, take field measurements and verify field conditions.


Sigma Prime Geosciences, Inc. 332 PRINCETON AVENUE HALF MOON BAY, CA 94019 (650) 728-3590 FAX 728-3593


EROSION CONTROL PLAN

SHEET	NO.	
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795 MAIN ST. HALF MOON BAY, CALIFORNIA APN 056-192-160



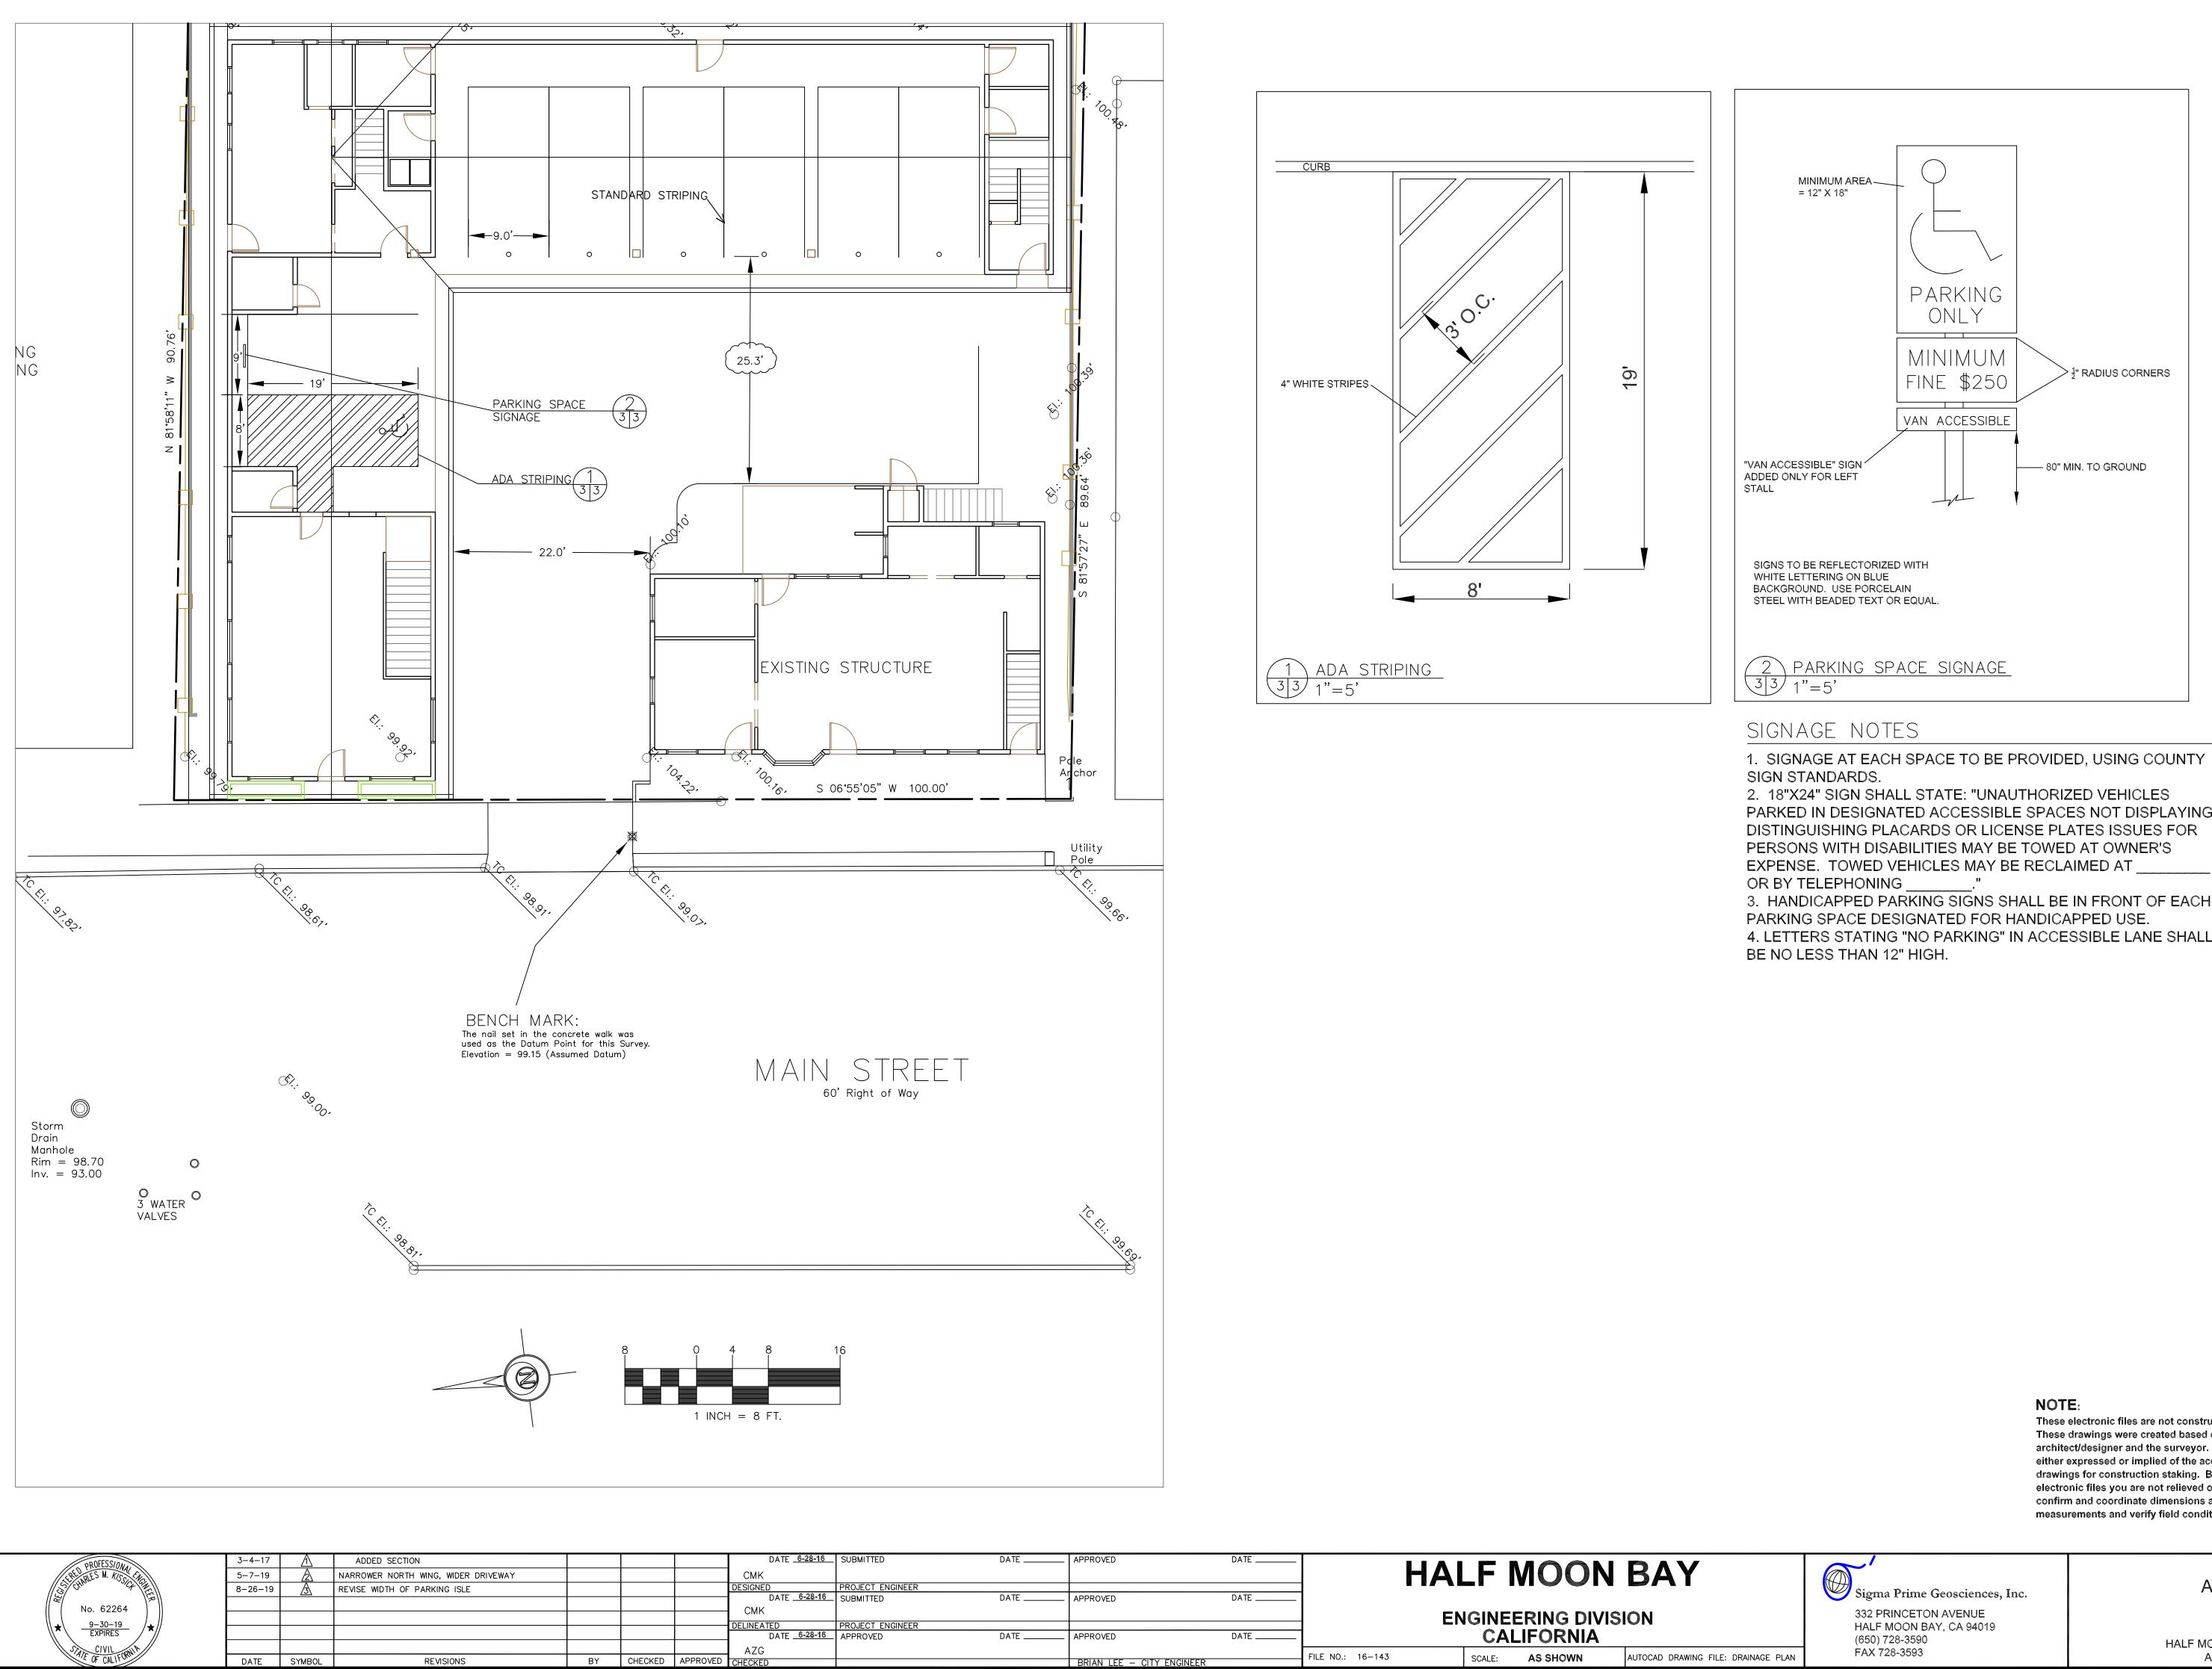

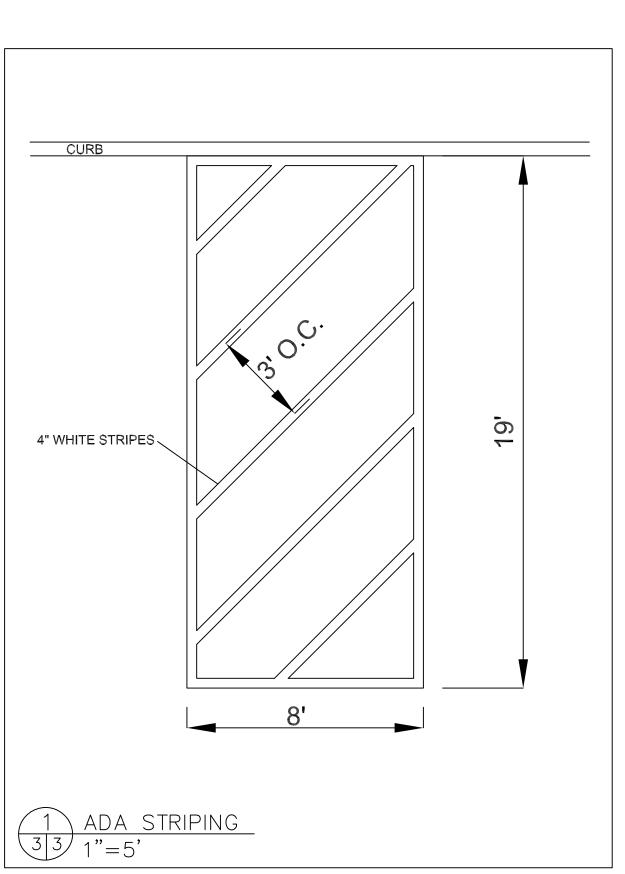

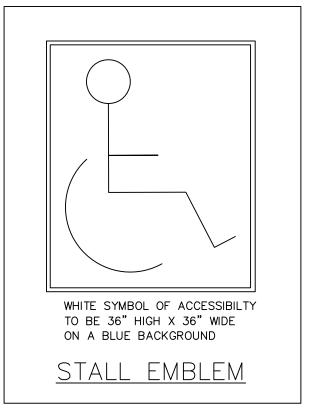PARKED IN DESIGNATED ACCESSIBLE SPACES NOT DISPLAYING


3. HANDICAPPED PARKING SIGNS SHALL BE IN FRONT OF EACH 4. LETTERS STATING "NO PARKING" IN ACCESSIBLE LANE SHALL


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SHEET	NO.	
	3	
	- OF	
	4	
		SHEETS

795 MAIN ST. HALF MOON BAY, CALIFORNIA APN 056-192-160



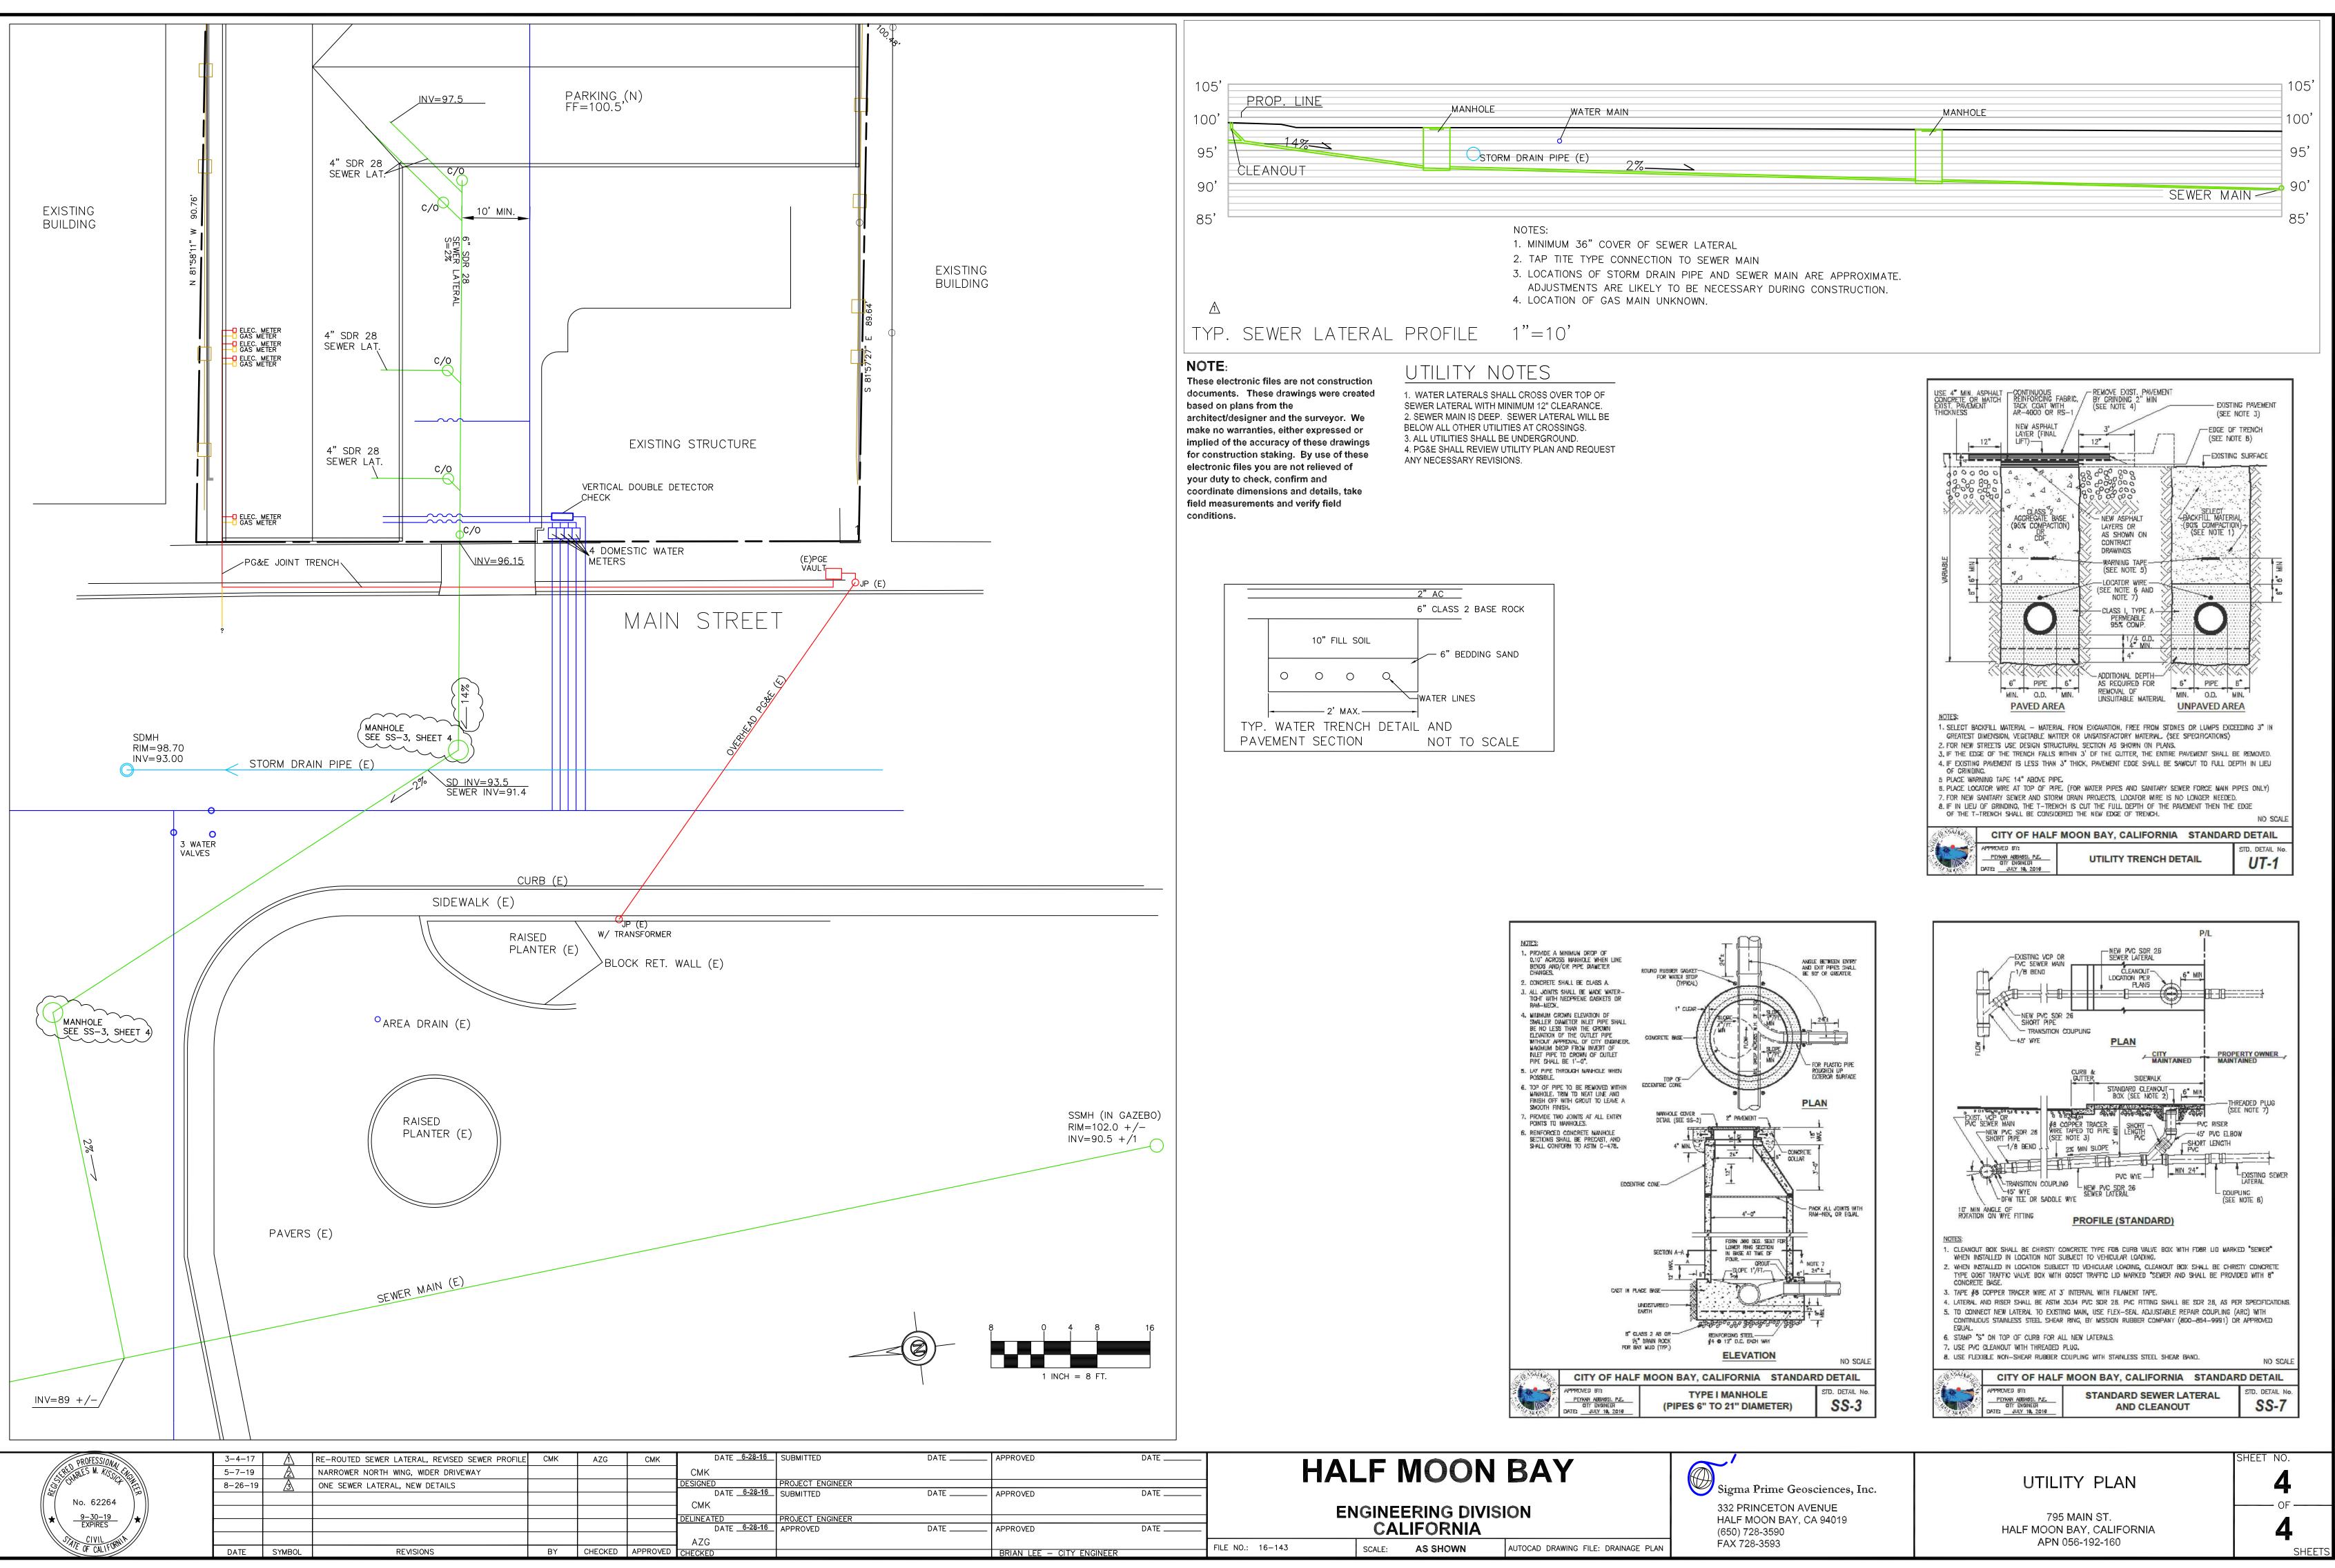

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1. J. J. (. (.)

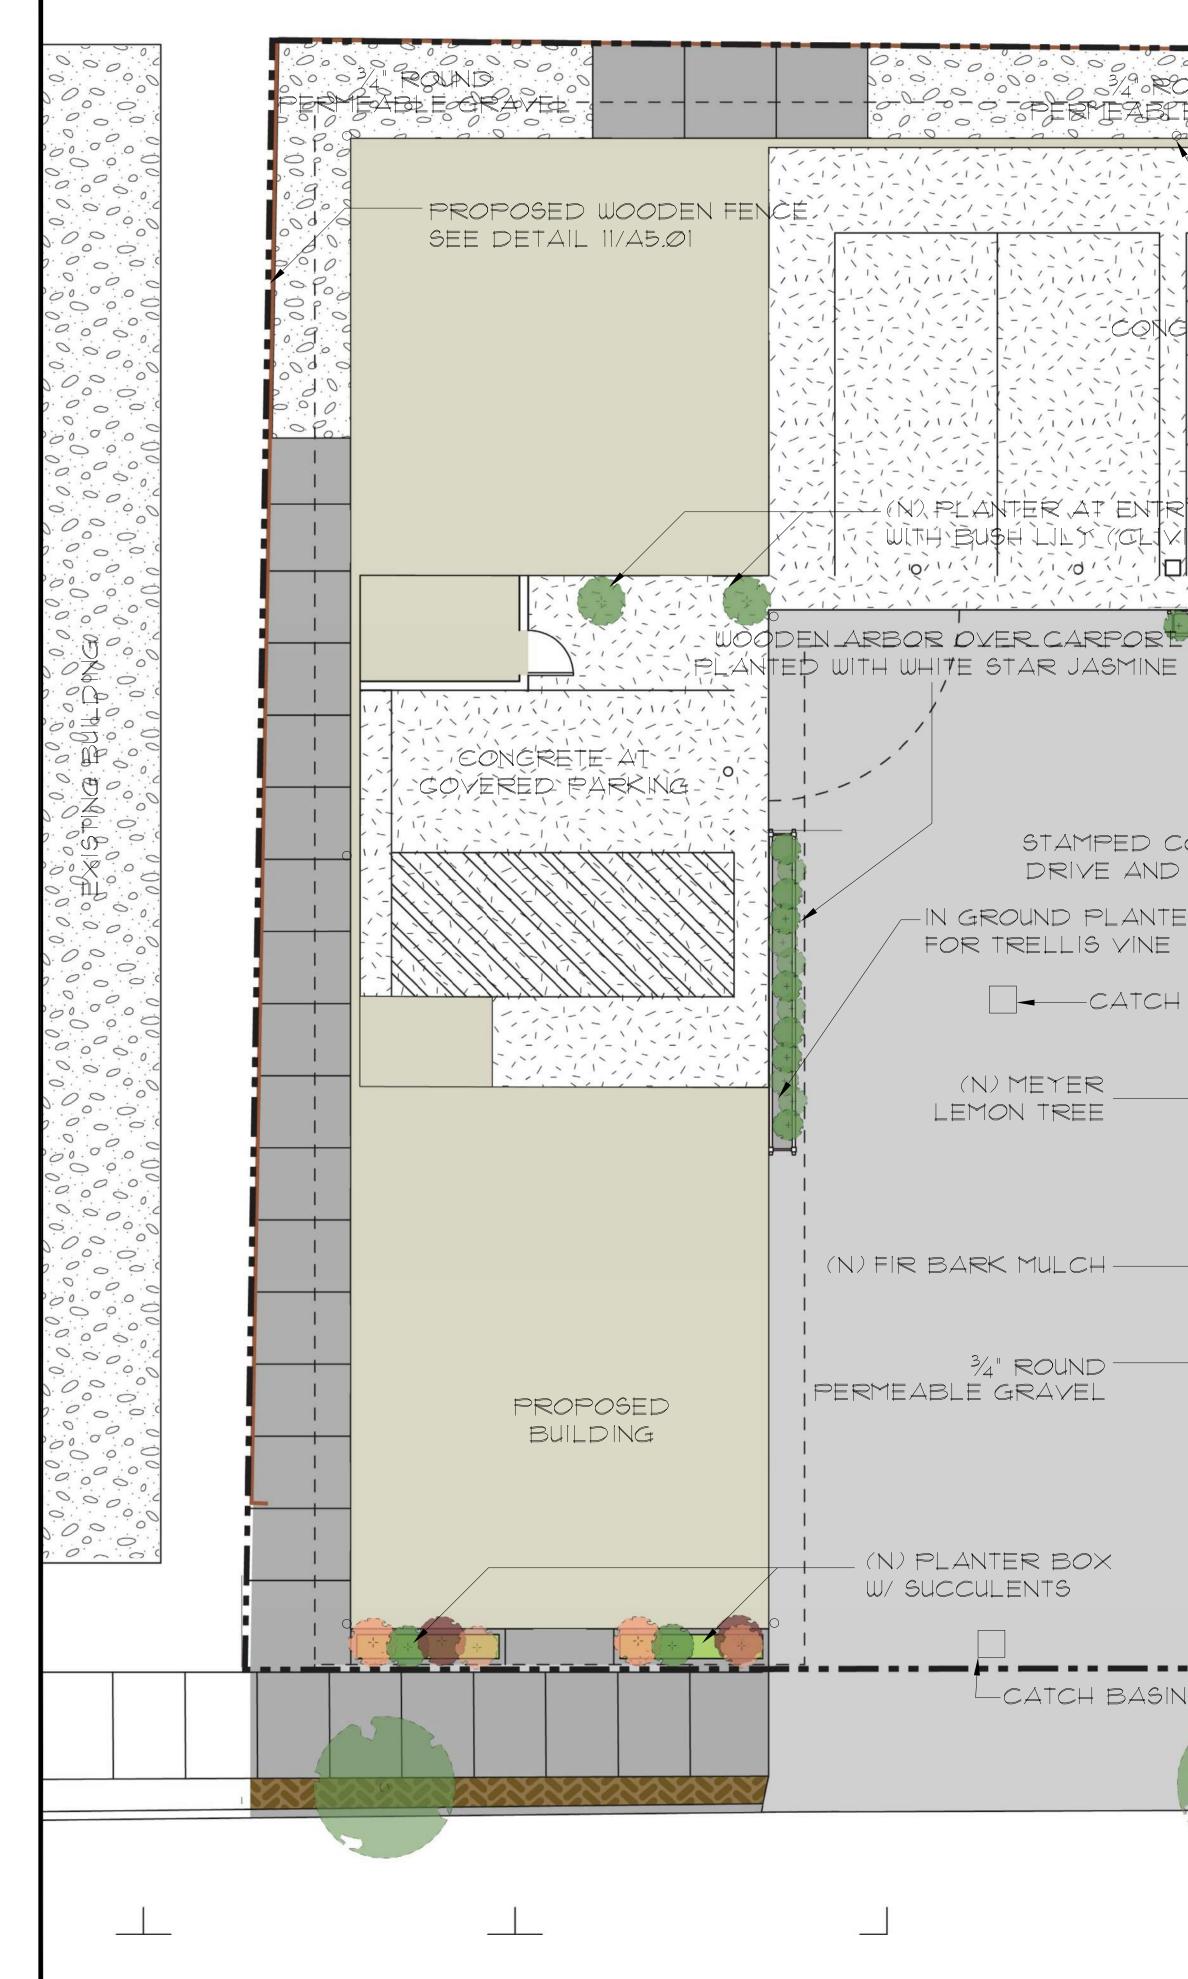(N) MEYER LEMON TREE

(N) FIR BARK MULCH

 $\frac{3}{4}$ " ROUND PERMEABLE GRAVEL

> (N) PLANTER BOX W/ SUCCULENTS

> > LCATCH BASIN, S.d.D



-(N) MAYTEN TREE (TYPICAL OF 3)

EXISTING L	ANDSCAPE
COVERAGE	E: 202 SF

PROPOSED LANDSCAPE COVERAGE: 260 SF

PLANTING LEGEND TYPE

TYPE	SIZE	QUANT.
MATTENUS BOARIA	15-GAL	3
AMELANCHIER X GRANDIFLORA	15-GAL	1
CLIVIA MINIATA	5-GAL	2
CITUS LIMON 'MEYER IMPROVED"	15-GAL	1
JASMINUM POLYANTHUM	5-GAL	2
SUCCULENT ASSORT.	EXST.	EXST.

795 MAIN STREET

RM CONSTRUCTION HALF MOON BAY, CA



ISSUES AND REVISIONS

NO. DATE 04.11.18 07.01.19

DESCRIPTION 08.26.16 PLANNING SET 05.10.17 PLANNING RESUBMITTAL PLANNING RESUBMITTAL PLANNING RESUBMITTAL 08.30.19 PLANNING RESUBMITTAL

PROJECT NUMBER 160401

SHEET TITLE CONCEPTUAL LANDSCAPE PLAN

> SCALE 3/16" = 1'-0"

SHEET NUMBER



STAMPED CONCRETE